MAR

1 2018



TENNESSEE DEPARTMENT OF ENVIRONMENT AND CONSERVATION

Division of Water Resources

William R. Snodgrass Tennessee Tower, 312 Rosa L. Parks Avenue, 11th Floor, Nashville, Tenhessee 37243 CONSERVATION
1-888-891-8332 (TDEC)

Notice of Intent	(NOI) for G	eneral NPDE	S Permit for St	tormwate	er Discharges from Co	onstruction Ad	tivities (T	NR100000)
Site or Project Name						NPDES Track Number: TNR	ing 2401	91
Street Address ot -	7 Modio	al Conto	r Dorkway	, 0 11	onlonger Du	Construction S		
or Location: Lot	/ Wedica	ai Cente	r Parkway	/ & IVI	aplegrove Dr.	Estimated End		
Site Description: Utilitie						Latitude (dd.d		
Description: Other	cs, site	gradin	g, bulluli	ig co	ristruction	Longitude (-do	d.dddd): -86	8.398322
County(ies): Ruth	erford		MS4 Jurisdi (if applicable	iction M	urfreesboro	Acres Disturbe		
If wetlands are located	d on-site and	may be impa	cted, attach we	tlands de	adjacent to the construction report. his site, what is the pe		ams [Wetlands
Receiving waters: We	st Fork Ston	es River (Ful	lly Supporting)					
Attach the SWPPP wi	th the NOI:	SWPPP	Attached		Attach a site location n	nap: Mar	Attached	
over construction plans	s and specific	cations): Re	dstone Fe	deral	or entity that has opera			
or corporate entitles on incorrect SOS cont	only, provide	correct Tenn	essee Secretar	y of State	(SOS) Control Number	er: Charter #	+ - 7544	
Site Owner or Develop leff Cooper			ual responsible	for site)	Title or Position: (the Sr. Assistant Vic			ication below)
Mailing Address: 220	Wynn D	r.			City: Huntsville	State: AI	abama	Zip: 35893
Phone: (256 722	-3797	Fax: (256)	722-4883		E-mail: jcooper@redfcu.org			
Optional Contact: Tol	ny Mitche	ell			Title or Position: Fac	cilities Ma	nager	
lailing Address: 220		r.	***************************************		City: Huntsville	State: A1. Zip: 35893		
hone: (254)722-3	3722	Fax: (251)	722-4883	***************************************	E-mail: tmitchell@redfcu.org			
wner/Developer(s)	Certification:	(must be sign	ned by president	, vice-pre	sident or equivalent, or r	anking elected	official) (Pr	imary Permittee)
ertify under penalty of law	w that this docu	ment and all a	tachments were p	repared by	y me, or under my direction there are significant pena on 39-16-702(a)(4), this dec	or supervision.	The submitte	ed information is to the
wner/Developer Nam					Signature:	56	Date	3-1-2018
wner/Developer Nam	e (print/type):	TONY M	ritchell		Signature:	Millell	Date:	3-1-2018
ontractor Certification	n: (must be	sianed by pre	sident vice-pre	esident or	equivalent, or ranking	elected official	\ /Spenned	on Dornittee
ertify under penalty of law uner/developer identified curate. I am aware that the undersite are the	w that I have re above and/or r his NOI, if appr areby regulated	viewed this doo ny inquiry of the oved, makes the . I am aware the	cument, any attache person directly rate above-described at there are sloulf	nments, an responsible d construct	d the SWPPP referenced at for assembling this NOI attion activity subject to NPD littles, including the possibility of Code Annotated Section	above. Based on and SWPPP, I be DES permit number	my inquiry of the interest of	of the construction site formation submitted in 00, and that certain of
ontractor name, addre	ess, and SOS	control num	ber (if applicable	e):	Signature: ////	7	Date:	
erselors revenus.					13/62	Januario.		, .
CIAL STATE USE ONLY		200	37211					127/18
3-1-18_	Revlewer:		Field Office:	1	Permit Tracking Number: TNR 240	191 02	Exceptional	TN Water:
/60.	T & El Wigsani	Flora/Fauna N FIE RECEIVED	SOS Corporate Sta	alus:	Waters with Unavailable Par	ameters:	Notice of Co	verage Dale: 23-18
-0940 (Rev. 9-16)				(Page 1	of 2)	***************************************	ine in agreement of the control of t	RDA 2366
		AR - 7 2						NON ZOU
	ENVIRON		ERVATION]				

TENNESSEE DEPT OF ENVIRONMENT 30157 Redstone Federal Credit Union

03/02/2018

Payment Invoice Amount Discount Reference Invoice Date 100.00 0.00 100.00 02/28/2018 022818/100.00 100.00 TOTAL

NOTICE TO CUSTOMER

The purchase of an indemnity bond may be required before the check will be replaced or refunded in the event it is lost, misplaced or stolen.

Redstone Federal Credit Union		TENNESSEE DEPT OF ENVI	RONMENT 30157	03/02/2018
Invoice Date	Reference	Invoice Amount	Discount	Payment
02/28/2018	022818/100.00	100.00	0.00	100.00
			TOTAL	100.00

NOTICE TO CUSTOMER

The purchase of an indemnity bond may be required before the check will be replaced or refunded in the event it is lost, misplaced or stolen.

TN DEPT. OF ENV. & CONSERVATION

MAR 0 7 2018

DIVISION OF WATER RESOURCES

THIS CHECK IS VOID WITHOUT A BLUE & BURGUNDY BACKGROUND AND AN ARTIFICIAL WATERMARK ON THE BACK - HOLD AT AN ANGLE TO VIEW

EDSTON FEDERAL CREDIT UNION

Accounts Payable 220 Wynn Drive Huntsville, AL 35893

PAY TO THE TENNESSEE DEPT OF ENVIRONMENT ORDER OF

61-7583/2622

30157

03/02/2018

\$ ***100.00

One Hundred and 00/100*******

Void After 6 Months

TENNESSEE DEPT OF ENVIRONMENT WILLIAM R SNODGRASS TENN TOWER 312 ROSA L PARKS AVE 11TH FL NASHVILLE, TN 37243

SIGNATURE HAS A COLORED BACKGROUND . BORDER CONTAINS MICROPRINTING

Notes:


- 1) Engineering Department Point of Contact is Cey Chase-Aguzzi, 615-893-6441; CChase-Aguzzi@MurfreesboroTN.gov
- 2) Planning Department Point of Contact is Margaret Ann Green, 615-893-6441; MGreen@MurfreesboroTN.gov
- 3) Contractor To Coordinate With The Traffic Engineer In The City Transportation Department Prior To Commencement Of Work In The Area To Avoid Damage To Traffic Signal Devices. Contact Ram Balachandran @ 615-893-6441

Redstone Federal Credit Union

Murfreesboro, Tennessee Final Design Review Set Site Plan & Construction Drawings

Drawing Index

Sheet No.	Title
C0.00	Cover Sheet
C1.00	General Notes
C2.00	Existing Conditions/Initial EPSC
C3.00	Site Plan
C3.01	Utility Plan
C3.02	Road Improvement Plan
C4.00	Grading, Drainage & Final EPSC Plan
C5.00	Details
C5.01	Details

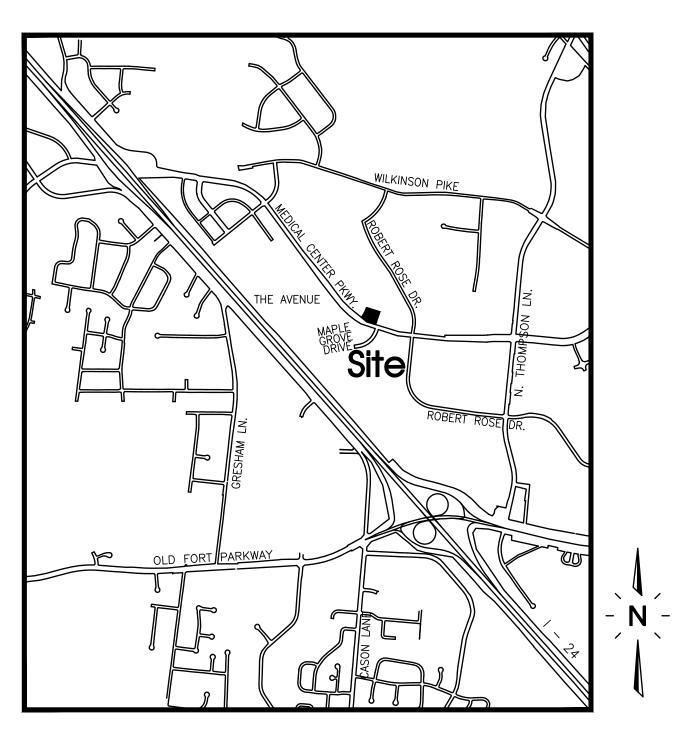

Site Location Map

Owner/Developer:

Redstone Federal Credit Union 220 Wynn Dr. Huntsville, AL 35893

Deed Reference: Tax Map 92, Parcel 8.12 R.Bk. 1534, Pg. 1581 P.Bk. 39, Pg. 68, Lot 7

Yard Requirements:

Front: 15' (Along Local Streets)
50' (Along Medical Center Parkway)

Rear: 20'

Intended Use:

Bank Branch (With Drive-Thru), Office Building

Land Use Data:

Zoned: MU
3-Story Building
Building Ht.: 48'-0"
Net Floor Area: 18,560 Sq.Ft.
1 Lot on: 1.81± Acres

Parking Requirement:

Parking Requirement:

1/300 Sq.Ft. x 18,560 Sq.Ft. = 62 Spaces Required
Provided: 61 Regular + 3 H.C. = 64 Total Spaces Provided
Flood Map No.:
This site lies within Zone X, not in the
100 Year Floodplain, per Community Panel
47149C0260H dated January 5, 2007.



850 MIDDLE TENNESSEE BOULEVARD MURFREESBORO, TENNESSEE 37129

PHONE: (615) 890-7901 E-MAIL: MTAYLOR@SEC-CIVIL.COM FAX: (615) 895-2567

NO PORTION OF THIS DRAWING MAY BE REPRODUCED WITHOUT THE EXPRESSED WRITTEN CONSENT OF S.E.C. INC.



Matthew A. Taylor, P.E. TN. Reg. #112515

Watershed: West Fork Stones River (Fully Supporting)

Disturbed Area: 1.96± Ac. Impervious Area: 1.25± Ac.

Site Plan Notes: . Contractor shall immediately notify the engineer of any discrepancies found between these plans, the architectural plans, and/or field conditions prior to construction. 2. Apparent errors, discrepancies, or omissions on the drawing shall be brought to the attention of the owner prior to bid submittal. The contractor may not use apparent errors, discrepancies, or omissions present on the drawings presented for bidding for additional charges after bids have been submitted. The architect shall be permitted to make corrections and interpretations as may be deemed necessary for the fulfillment of the intent 3. The contractor shall stake all improvements using the geometric data provided in the drawings. It is the sole responsibility of the contractor to completely stake and check all improvements to ensure adequate positioning, both horizontal and vertical, prior to the installation of any improvements. No digital file will be provided. 4. The notes and plans shown call attention to certain required features of the construction but do not claim to cover all details of design and construction. The contractor shall furnish and install the work complete and ready for operation. materials, equipment, and other deleterious materials associated with construction. The contractor is expressly responsible for ensuring the site is clean and in operable condition at the time of final acceptance. 6. The contractor is responsible for the protection and replacement of all property pins on this site. drawings may not be used in whole or in part on any other project under the professional engineer's seal. The owner shall hold harmless and indemnify the architect and engineer from and against any and all claims of any 8. The contractor shall stake all improvements using the geometric data provided in the drawings. It is the sole responsibility of the contractor to completely stake and check all improvements to ensure adequate positioning, both horizontal and vertical, prior to the installation of any improvements. No digital file will be provided. Coordinates referenced are for construction staking purposes and are site assigned. They should be considered 10. All parking space striping and markings on site shall be 4" wide white painted stripes. Other markings shall

10. Site shall be graded to subgrade before water lines and sanitary sewers are installed. 12. Asphalt paving: do not apply prime and tack coats when temperature is below 50° F, or when base is wet. Apply asphalt paving only when temperature is above 40° F and when base is dry. 13A) Subgrade: Cohesive subgrade shall be compacted to 96% compaction. Cohesion less subgrade shall be compacted to 100% compaction. 13B) Subbase: Unless otherwise noted on these plans, base shall consist of water bonded limestone, 13C) Asphalt: Bituminous concrete hot plant mix binder course and asphalt topping plant mix shall be applied over base, minimum temperature time of placement shall be 225° F. 4. Cast in place concrete: All concrete work shall conform to all requirements of American Concrete Institute ACI 301 and applicable sections of ASTM C-94 (latest ed.) for ready mixed concrete. 15. All concrete shall be in-transit mixed concrete, 5% air-entrained and shall attain a minimum compression strength of 4,000 p.s.i. in twenty-eight (28) days. 1. The contractor must notify MWRD for sewer inspection prior to starting work. 16. Slump: Maximum allowable slump will be five (5) inches. 17. Concrete Materials: connection fees which may be substantia 17A) Portland cement: Gray portland cement, ASTM C-150 (latest ed.) type 1. All concrete shall contain not less than five bags of cement per cubic yard.

17B) Aggregates: ASTM C-33 (latest ed.).

17C) Sand: Hard, durable, clean, sharp, natural sand free from clay, loam, dust or organic matter. 17D) Water: Clean, potable, free from oil, acids, alkali, organic matter and other deleterious substances. 17E) Admixture: Air type to meet ASTM C-260 (latest ed.)

General Utility Notes:

18A) Curing Compound: "Horncure 300" as manufactured by A.C. Horn Company, (800) 654-0402. This 19. Reinforcing materials shall be uncoated and free from excessive rust, mill scale, oil, grease and other deleterious matter. No. 4 Bars 16" O.C. both ways. Joints to be sawed at 15" foot centers for transverse and 20. All above grade exterior concrete surfaces shall be cured with curing compound sprayed on in strict compliance with manufacturer's directions.

unless the following special procedures have been included in the contract and reviewed by the engineer: temperature of the concrete when placed shall not be greater than 90° F. Procedures for , retarding and protecting in—place concrete during hot weather shall be in accordance with 5. Provide special procedures required to control concrete temperature and to protect surfaces from drying out, mixing water may be chilled or chopped ice may be used to control temperature provided water equivalent of ice is calculated to total amount of mixing water, use of iquid nitrogen to cool concrete is the contractor's option.

21B) Cold Weather Placing: Do not mix or place when atmospheric temperature will fall below 40° F, or when conditions indicate temperature will fall below 40° F within 72 hours. Concrete deposited shall have temperature not less than 60° F. Reinforcement, forms and ground which concrete will contact shall be completely free of frost. Keep concrete and form work at a temperature not less than 50° F for not less than 72 hours after pouring. Comply with requirements of ACI 305 (latest

22. Concrete tests shall be authorized by the owner on an as needed basis. 23. All exterior curb shall have expansion joints at 100'-0" O.C., and construction joints at 10'-0" O.C. (unless

24. All concrete shall have a medium transverse finish. 25. Subgrade shall be free of extraneous materials. Proof-roll soil subgrade with heavy, pneumatic tired equipment immediately prior to placing stone base. Any soft or unstable zones detected thereby shall be undercut to firm soil and backfilled with engineered earth fill compacted as specified. The subgrade for all pavements shall be uniformly stable before any stone base is installed. No base materials shall be placed if the

26. Surface preparation, spreading and laying, compacting and rolling operations shall conform with asphalt institute recommended specifications.

27. Inspect area to be paved and ensure that all subgrade conditions are sufficiently carried out to ensure a

good paving job. A finished surface shall not vary more than 1/8" in 10 feet when tested with a straight edge applied parallel with, or at right angle, to centerline of asphalt surface. Humps or depressions which exceed specified tolerances or which retain water shall be immediately corrected by removing the defective work and replacing it with new material at the contractor's expense. **Grading And Drainage Plan Notes:**

. The site work contractor shall coordinate the installation of all underground utilities with his work. All underground utilities (water, sanitary sewer, storm sewer, electrical conduit, irrigation sleeves, and any other miscellaneous underground utilities, devices, or structures), shall be in-place prior to the placement of base course 2. The contractor shall cut existing pavement as necessary to assure a smooth fit and continuous grade.

3. The contractor shall verify horizontal and vertical location of all existing storm sewer structures, pipes and all utilities prior to construction 4. Clearing and grubbing limits shall include all areas disturbed by grading operation. 5. The soil materials shown hereon may be disturbed by cutting or filling operations performed during or before development. Therefore, the builder of any proposed structure shall investigate the current conditions and consult with a geotechnical expert or other qualified person as he deems appropriate to assure himself that the design of

6. No portion of this site lies within a 100 year flood hazard area, as defined by F.E.M.A. Community Panel No. 47149C0265H dated January 5, 2007. . Before starting grading operations, see sheet 3 Existing Conditions/Initial EPSC plan notes and details.

the proposed foundation is adequate

8. Before starting grading operations, see landscape plan and Geotechnical Engineering report for treatment of 3. Prior to site construction activity, the contractor shall install all SWPP measures to protect existing drainage

facilities. Contractor shall prevent siltation from leaving the site at all times.

10. Strip building and pavement areas of all organic topsoils. Stockpile suitable topsoils for respreading onto landscape areas. All excess excavated materials shall be removed from the site at the contractor's expense. See Site grading shall be performed in accordance with these plans and specifications and the recommenda

set forth in the Geotechical Engineering report referenced in this plan set. The contractor shall be responsible for removing all soft, yielding or unsuitable materials and replacing with suitable materials as specified by the 12. Contractor shall submit a compaction report prepared by a Licensed Geotechnical Engineer, verifying that all filled areas and subgrade areas within the building pad area and areas to be paved have been compacted in

accordance with these plans and specifications and the recommendations set forth in the Geotechnical Engineeri report. Notify project engineer if any unsuitable soils are found. 13. Compaction testing is mandatory for parking lot, building slab and foundations sub-grade

14. Fill under paved areas and slabs on grade shall be compacted per specifications and geotechnical report. Deposit fill material in horizontal layers as recommended by Geotechnical Engineer and compact each layer with a mechanical tamper. Base course pavement shall be compacted to 100% standard proctor. 15. It is the earthwork contractor's responsibility to maintain the site soils and engineered fills with a workable moisture content range to obtain the required in—place density. Scarifying and drying operation should be included in the contractor's price and should not be considered and extra for the contract. The contractor shall review the a report and be aware of all moisture concerns and soil remediations requiremen

16. Following grading of subsoil to subgrade elevations the contractor shall place topsoil to a depth as specified on L.A. Plans in all disturbed areas which are not to be paved. Smoothly finish grade to meet_surrounding lawn areas and ensure positive drainage. Stockpiled topsoil shall be screened prior to respreading. Topsoils shall be free of subsoil, debris, brush and stones larger than 1" in any dimension. Rock hounding in place will not be permitted. All excess topsoil shall be legally disposed of off site.

17. After fine grading topsoil, contractor shall stabilize per L.A. plans, mulch, fertilize and water until a healthy stand of grass is obtained. The restoration shall closely follow construction.

18. Elevations given are at bottom face of curb and/or finished pavement grade unless otherwise specified on grading plan. All pavement shall be laid on a straight, eve, and uniform grade with a minimum of 1% slope toward the collection points unless otherwise specified on the grading plan. DO not allow negative grades or 19. Contractor shall provide butt end joint to meet existing pavement in elevation at drive returns and ensure

1. Contractor shall contact all utility companies immediately after bid is awarded and ensure the utility companies

engineer of any time frames established by utility companies which will not meet opening date. 2. Existing utility lines shown are approximate locations only. Contractor shall verify the size, location, invert elevation, and condition of existing utilities which are intended to be utilized as a connection point for all propose utilities (see sheet), prior to any construction. Contractor to ensure existing utilities are in good condition and free flowing (if applicable). If elevations, size, or location differ from what is shown on sheet, contractor shall

have the essentials required for complete service installation. Contractor shall notify construction manager and

3. The contractor will provide all necessary protective measures to safeguard existing utilities from damage during construction of this project. In the event that special equipment is required to work over and around the utilities the contractor will be required to furnish such equipment. The cost of protecting utilities from damage and

4. The contractor shall notify each individual utility owner of his plan of operation in the area of the utilities, prio to commencing work, the contractor shall contact the utility owners and request them to properly locate their respective utility on the ground. This notification shall be given at least three (3) business days prior to commencement of operations around the utility.

5. The contractor shall coordinate installation of utilities in such a manner as to avoid conflicts and assure prope depths are achieved as well as coordinating with the regulatory agency as to location and scheduling of

6. All underground utilities (water sewer, storm sewer, electrical conduit, irrigation sleeves, and any other 7. Utility contractor will be responsible for all tap and tie on fees required, as well as cost of underground

service connections. 8. No more than 25 percent of the dollar amount of the contract may be awarded to subcontractors.

specifications and drawings shall be kept. The contractor shall also designate to the owner a person to be notified in Murfreesboro in case of emergencies other than during working hours and on holidays and weekends.

11. All mainline waterline taps are to be made by C.U.D.(Consolidated Utility District).

12. Contractor shall comply with all requirements of the latest edition of C.U.D.'s specifications.

13. In Tennessee it is a requirement per "the Underground Utility Damage Prevention Act" that anyone who engages in excavation must notify all known utility owners, no less than three nor more than ten working days, prior to their intended excavation. A list of these utility owners may be obtained from the county register of deeds those utility owners who participate in the Tennessee one call system can be notified toll free at (800) 351-1111.

14. Where cleanouts, castings, valve boxes, fire hydrants, etc. are encountered and are to remain in use, in area where elevations are to change or be paved, those features are to be adjusted to match proposed finished

2. The owner/developer for budget purposes, should check with the Murfreesboro Water Resources Department for

3. Contractors for sewer work must be approved by the Murfreesboro Water Resources Department.

4. Coordinates or dimensions shown are to centerline of pipe or fitting or to centerline of manhole 5. The top elevation of all manholes in paved areas shall match finish grade. The top elevation of all manholes

in grassed areas shall be 6" above finished grade. 6. The minimum horizontal separation between the closest two points of the water and sewer line is ten (10) feet. The minimum vertical separation between the closest two points of the water and sewer line shall be 18

7. Complete specifications for the sewer lines, "Sewer_Line Specifications and Drawings", March 2014 Ed., are or file at the Murfreesboro Water Resources Department Engineering Annex and can also be found online at http://www.murfreesborotn.gov/index.aspx?NID=284

8. Sanitary sewer wyes and 45° bends are to be the same material and class/wall thickness as the mainline pipe 9. All services shall be constructed such that the invert of the pipe at the property line is no less than 3 1/2

10. Under the current adopted plumbing code, the City of Murfreesboro requires the minimum floor elevation (M.F.E.) to be set at or above the top of casting elevation of the nearest manhole that is upstream of the sewe service connection. As an alternative, the homeowner shall install a backwater valve per the plumbing code and execute and record a release of indemnification against the City of Murfreesboro with regards to the sanitary sewer connection. The builder and/or homeowner shall be responsible for compliance with this requirement.

11. Check dams, as called out in the MWRD Specifications, are to be installed at the discretion of the Water Resources Department.

12. Sewer construction must be in accordance with all MWRD specifications and drawings.

13. Contractor must have a State of Tennessee license, Municipal Utility (MU) classification, to perform work 14. The existing sewer main and/or manholes utilized or altered by this project must be tested before and after construction. Should the sewer not be tested prior to construction and defects found after construction will be e responsibility of the contractor to repair at his or her expense.

15. All proposed manholes must be wrapped in a Conseal, or an approved equal, 12" minimum water and soil barrier wrap at each manhole section joint and at any other manhole component as directed by MWRD. 16. No more that 25 percent of the dollar amount of the Contract may be awarded to subcontractors.

17. A maximum of 2-6" (6 in.) adjustment rings will be allowed per any existing or proposed manholes associated with this installation. If any manhole requires adjustment beyond the 2-6" adjustment rings allowed then the contractor must remove, adjust, or add barrel sections to the manhole to get it to grade at his or her

18. In accordance with TCA Section 7-59-310(b)(1), Competitive Cable and Video Services Act, in cases of new construction or property development where utilities are to be placed underground, the developer or property owne shall give all providers of cable or video serving the City of Murfreesboro dates on which open trenching will be available for the providers' installation of conduit, pedestals or vaults, and laterals, referred to as "equipment," to

19. All newly constructed sanitary sewer mains, rehabilitated sanitary sewer laterals and mains, existing sanitary sewer mains that intersect under or over a newly constructed or removed utility, or any sewer main that has bee physically altered in any way must be fully televised via an in-line Closed Circuit Television (CCTV) post construction survey fully compliant with the guidelines set forth by the National Association of Sewer Service Companies' (NASSCO) Pipeline Assessment Certification Program (PACP) at the expense of the contractor.

Natural Gas Notes:

. Construction And Materials Provided By The Gas Company

20. Site is within the Overall Creek & Medical Center Parkway Sanitary Sewer Assessment Districts.

 Furnish and install meter. - Coordinate all work with Atmos Energy, Jerry Burke @ 615-566-3085 or Stephen Morris @ 615-893-5672 Construction and Materials Provided By The Contractor: Furnish and install service lateral, including all trenching and backfilling.
 Contractor shall include all fees required by the gas company to provide a complete working service.

- Furnish and install mainline extension, including all trenching and backfilling.

Waterline Notes:

. All mainline taps are to be made by C.U.D. All water mains shall be hydrostatically tested and disinfected before acceptance.

3. All trenches, pipe laying, and backfilling shall be in accordance with federal O.S.H.A. regulations.

. Contractor shall comply with all requirements of the latest edition of the CUD specifications.

The developer must post bond, \$2,000 or \$250 for each valve box (whichever is greater), whenever the subject

project has valve boxes that are located within pavement upon completion of the proposed water system extension.

The owner/developer for budget purposes should contact CUD for related fees to project which may be substantial. 8. The reduced pressure backflow preventer for the domestic water service must be above ground and outside

9. Dedicated fire line must be installed by licensed sprinkler contractor

10. Water Service materials shall be copper type "K" unless otherwise noted on plans. Diameter shall be as noted on these plans and shall be installed with a minimum cover of 42" or below frost line, whichever is greater.

11. Fire Main shall be ductile iron pipe pressure Class 350. 12. Construction and Materials Provided By The Water Company:

— <u>T</u>ap Main. Furnish and install curb stop and box and water meter.
 Coordinate all work with the City of Murfreesboro, Greg Harvey & 615-848-3200. - Coordinate fire metering with the Consolidated Utility District (CUD), Bryant Bradley @ 615-225-3340.

Construction and Materials Provided By The Contractor

- Furnish and install domestic & fire service service line from meter to building

Coordinate all work with the City of Murfreesboro, Greg Harvey @ 615-848-3200
 Coordinate with Bryant Bradley (CUD) @ 615-225-3340 for water meter specifications.
 Coordinate fire metering with the Consolidated Utility District, Bryant Bradley @ 615-225-3340

13. Contractor shall provide 100% irrigation per construction/project manager, irrigation plan, and city requirements. Coordinate sleeve locations with the construction/project manager and irrigation consultant prior to

City of Murfreesboro Standard Site Plan Notes:

. In accordance with TCA Section 7-59-310(b)(1), Competitive Cable and Video Services Act, in cases of new construction or property development where utilities are to be placed underground, the developer or property owner shall give all providers of cable or video serving the City of Murfreesboro dates on which open trenching will be available for the providers' installation of conduit, pedestals or vaults, and laterals, referred to as "equipment," to be provided at each such providers' expense.

2. All signage, including flags and flagpoles, is subject to independent review by the Building and Codes

3. A Land Disturbance Permit may be required. Determination whether a Land Disturbance Permit is required shall be made by the City Engineer. A separate Land Disturbance Permit application shall be made with the office of the City Engineer for review and upon approval for issuance of a Land Disturbance Permit. 4. For all developments of more than one acre, a State of Tennessee Construction General Permit is required. Evidence of this permit must be provided to the office of the City Engineer prior to construction commencement.

5. Contractor to coordinate with the Traffic Engineer in the City Transportation Department prior to commencement of work in this area to avoid damage to traffic signal devices. 6. A TDOT permit may be required. Evidence of TDOT approval is required prior to the issuance of any building

7. A Stormwater Management Plan demonstrating that the site provides for treatment of the water quality volume and provides for management of the stream bank protection volume must be provided. 8. An Engineers Certification of the construction of the stormwater management facilities must be provided to

the City Engineer prior to issuance certificate of occupancy. 9. A Stormwater Fee Credit Application must be submitted prior to the issuance of a building permit.

10. A Stormwater Facilities Operation and Maintenance Plan and a Stormwater Facilities Maintenance Agreement must be submitted prior to issuance of a building permit. 11. The Stormwater Facilities Maintenance Agreement must be recorded prior to certificate of occupancy.

PROJECT STATUS

ISSUED -

ISSUE DATE

REVISIONS

No. Description

SCHEMATIC DESIGN

NOT FOR CONSTRUCTION

APRIL 21, 201

Contractor To Coordinate With The **Traffic Engineer In The City Transportation Department Prior** To Commencement Of Work In The **Area To Avoid Damage To Traffic** Signal Devices. Contact Ram Balachandran @ 615-893-6441

SEC, Inc.

SITE ENGINEERING CONSULTANTS ENGINEERING • SURVEYING • LAND PLANNING LANDSCAPE ARCHITECTURE

850 MIDDLE TENNESSEE BOULEVARD MURFREESBORO, TENNESSEE 37129 NO PORTION OF THIS DRAWING MAY BE REPRODUCED WITHOUT THE EXPRESSED WRITTEN CONSENT OF S.E.C. INC. SEC Project #: 13260

BAKERS ROW, Suite 100

60 14th Street South

Birmingham, AL 35233

205.251.0125

www.kpsgroup.com

This Drawing is an instrument of service and is the

sole property of the Architect. Any use without the

written consent of the Architect is prohibited.

and shall not be responsible for construction

means and methods, deviations, techniques,

sequences, or procedures, or for safety

The Architect shall not have control or charge of

precautions and programs in connection with the

work, for the acts or omissions of the contractor,

subcontractors or any other persons performing

any of the work in accordance with the contract

1-22-18 IDR Comments 2-20-18 FDR Comments


DRAWING TITLE General Notes

DRAWN BY:

CHECKED BY PROJECT

> **BRANCH OFFICE** BANK

PROJECT NUMBER 165026-02 DRAWING NO

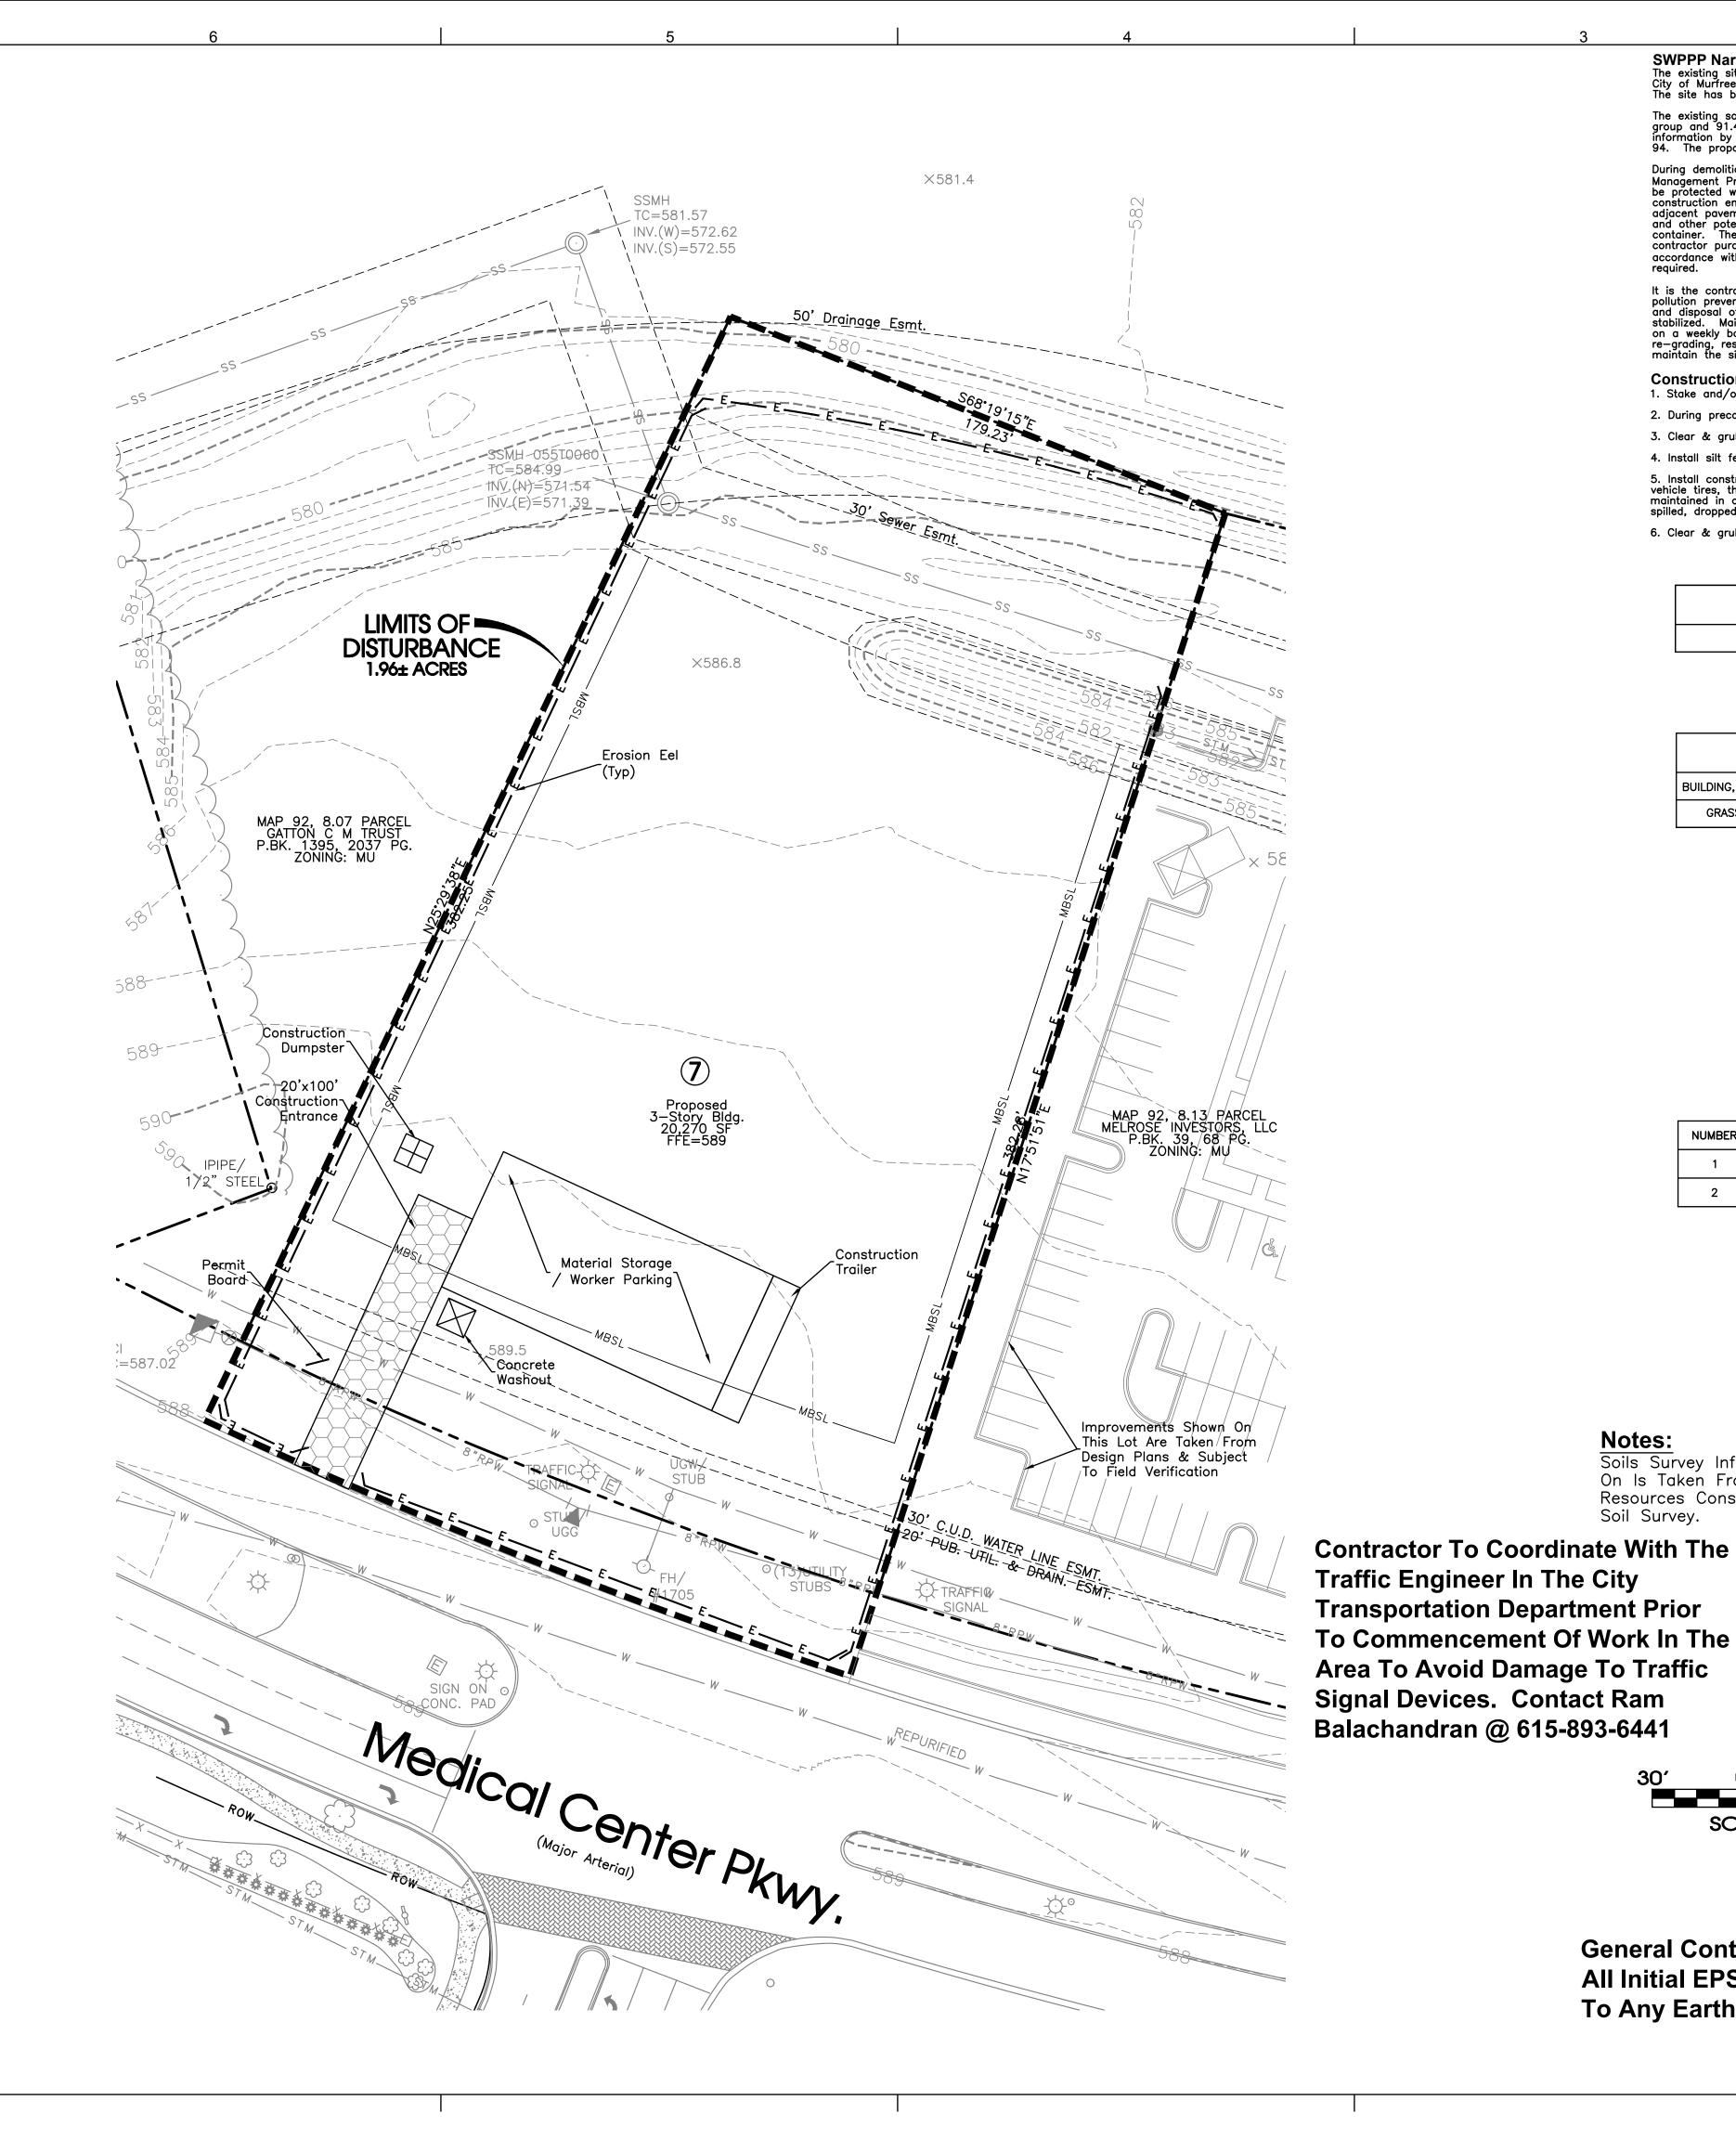

SWPPP Narrative:

The existing site is located to the south of Veterans Pkwy and east of Pitchers Lane within Rutherford County in the City of Murfreesboro. The project site is a 1.95 Acre project and generally sheet flows from the east to the west. The site has been designed to discharge to existing downstream conveyance system to the northwest.

The existing soils on site consist of approximately 8.6% Bradyville Silt Loam categorized as type C hydrologic soil group and 91.4% Harpeth Silt Loam and Lomond Silt Loam categorized as type B hydrologic soil group per published information by the National Resources Conservation Service. The pre—developed site has a runoff curve number of 94. The proposed improvements will increase the runoff curve number to 85.

During demolition and mobilization, the sediment and stormwater runoff will be controlled with certain Best Management Practices (BMPs). Silt fence will be installed on the downslope sides of the site. The storm inlets will be protected with silt fence inlet protection until the stone base and pavements can be installed. A stone construction entrance will be installed upon mobilization of site to limit the tracking of mud and sediment onto the adjacent pavements and roadways. Covered dumpsters will be on site for disposal of trash and other debris. Paint and other potentially hazardous chemicals will be stored inside the building or otherwise approved weatherproof container. The contractor purchasing the materials will be responsible for legally disposing of the container. The contractor purchasing the materials will be responsible for legally disposing of the containers and excess materials in accordance with the manufacturers' recommendations. A washout area will be provided for the concrete trucks as accordance with the manufacturers' recommendations. A washout area will be provided for the concrete trucks as

It is the contractor's responsibility during construction to install and maintain all sedimentation and storm water pollution prevention BMPs described above and detailed within the plans at all times, which includes regular removal and disposal of accumulated debris. All erosion and sediment controls must be maintained properly until the site is stabilized. Maintenance must include inspections of all erosion and sediment controls after each runoff event and on a weekly basis. All preventative and remedial maintenance work, including clean out, repair replacement, re—grading, reseeding, re—mulching and re—netting must be performed immediately. The developer will own and maintain the site after construction has been completed.

Construction Sequence:

1. Stake and/or flag limits of clearing.

Notes:

Soil Survey.

Soils Survey Information Shown Here On Is Taken From The National

Resources Conservation Service Web

SCALE: 1"= 30'

General Contractor Shall Install

All Initial EPSC Measures Prior

To Any Earthwork Beginning.

- 2. During preconstruction meeting all erosion & sediment control facilities & procedures shall be discussed.
- 3. Clear & grub, as necessary, for installation of perimeter controls.
- 4. Install silt fence perimeter controls as shown on plans.
- 5. Install construction entrance and concrete washout facility, if conditions are such that mud is collecting on vehicle tires, the tires must be cleaned before the vehicles enter the public roadway. The site entrance shall be maintained in a condition that will prevent the tracking or flow of mud onto the public right—of—way. All materials spilled, dropped, washed or tracked from vehicles onto the roadway must be removed promptly.
- 6. Clear & grub the remaining site as necessary.

EXISTING ON-SITE CONDITIONS

COVER	SCS CLASSIFICATION	AREA (Ac)		
GRASS	MASS GRADED SITE D SOILS, CN=94			
		СОМРО	SITE CN=	

PROPOSED ON-SITE CONDITIONS

COVER	SCS CLASSIFICATION	AREA (Ac)
BUILDING, SIDEWALK, PAVEMENT	PAVED PARKING LOTS, ROOFS, ETC. C-SOILS, CN=98	 -
GRASS / LANDSCAPING	OPEN SPACE: GOOD CONDITION C-SOILS, CN=61	
	СОМРО	OSITE CN=

PROPOSED BMP'S

ВМР	TYPE
SEDIMENT CONTROL BARRIER	TEMPORARY, SEDIMENT CONTROL
CONSTRUCTION ENTRANCE	TEMPORARY, SEDIMENT CONTROL
VEGETATION	PERMANENT, EROSION PREVENTION
INLET PROTECTION	TEMPORARY, SEDIMENT CONTROL

INITIAL OUTFALLS

NUMBER	DESCRIPTION	AREA	SLOPE
1	CONSTRUCTION EXIT	 -	1%
2	BOX CULVERT AT N.W. CORNER		1-2%



EPSC Phasing

Silt Fence Along Downgradient Perimeter Construction Entrance Temp. Conc. Washout

Intermediate:

Filter Fabric Inlet Protection Silt Fence To Protect Ditches

Landscaping & Grass Sod Of All Pervious Areas (See Landscaping Plan)

Notes:

Staging Area, Worker Parking & Adjoining Drive To Be Constructed Of

Staging Area is To Be Kept Litter Free With Daily Cleanup. In Addition, All Stored Materials Are To Be Kept In Organized & Stacked Fashion. An unkempt site will not be permitted, and if debris is stored in areas outside of the designated storage area, City Staff will shut down the job site.

All Construction Signage Is To Be Constructed Of 2-4"x4" Painted Posts.

Sign #1 — Display Surface Can Be No More Than 32 S.F. & Must Be Less Than 9 Ft. Tall.

	EXIST. CONCRETE					
	MONUMENT		BENCHMARK			
•	IRON PIN SET (I.P.S.)	Ġ	HANDICAP PARKING SYMBOL			
0	IRON PIN FOUND (I.P.F.)	V.A.	VAN ACCESSIBLE HANDICAP DESIGNATION		G R	O U
-	EXIST. SIGN POST	0	HC SIGN		BAKER	RS ROW, Suite 100
0	EXIST. SEWER CLEANOUT	-	PROPOSED SIGN POST		60 1	.4th Street South ngham, AL 35233
0	EXIST. MANHOLE (SEWER & PHONE)	•	CONCRETE BOLLARD	E		205.251.0125 w.kpsgroup.com
\ominus	EXIST. CATCH BASIN (STORM SEWER)		WHEEL STOP			n instrument of service and is he Architect. Any use without t
\otimes	EXIST. WATER/GAS VALVE		CONCRETE SIDEWALK			f the Architect is prohibited.
T	EXIST. TELEPHONE RISER		EXTRUDED CURB			III not have control or charge or esponsible for construction
G	EXIST. GAS RISER		CURB & GUTTER		means and metho	ods, deviations, techniques, ocedures, or for safety
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Know what's below. Call before you dig.

SEC, Inc.

SITE ENGINEERING CONSULTANTS

ENGINEERING • SURVEYING • LAND PLANNING
LANDSCAPE ARCHITECTURE 850 MIDDLE TENNESSEE BOULEVARD NO PORTION OF THIS DRAWING MAY BE REPRODUCED WITHOUT THE EXPRESSED WRITTEN CONSENT OF S.E.C. INC.

SEC Project #: 13260

DRAWING TITLE Existing Conditions / Initial EPSC

DRAWN BY:

BRANCH OFFICE

PROJECT NUMBER 165026-02


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PROPOSED WATER

CHECKED BY:

BANK

DRAWING NO.

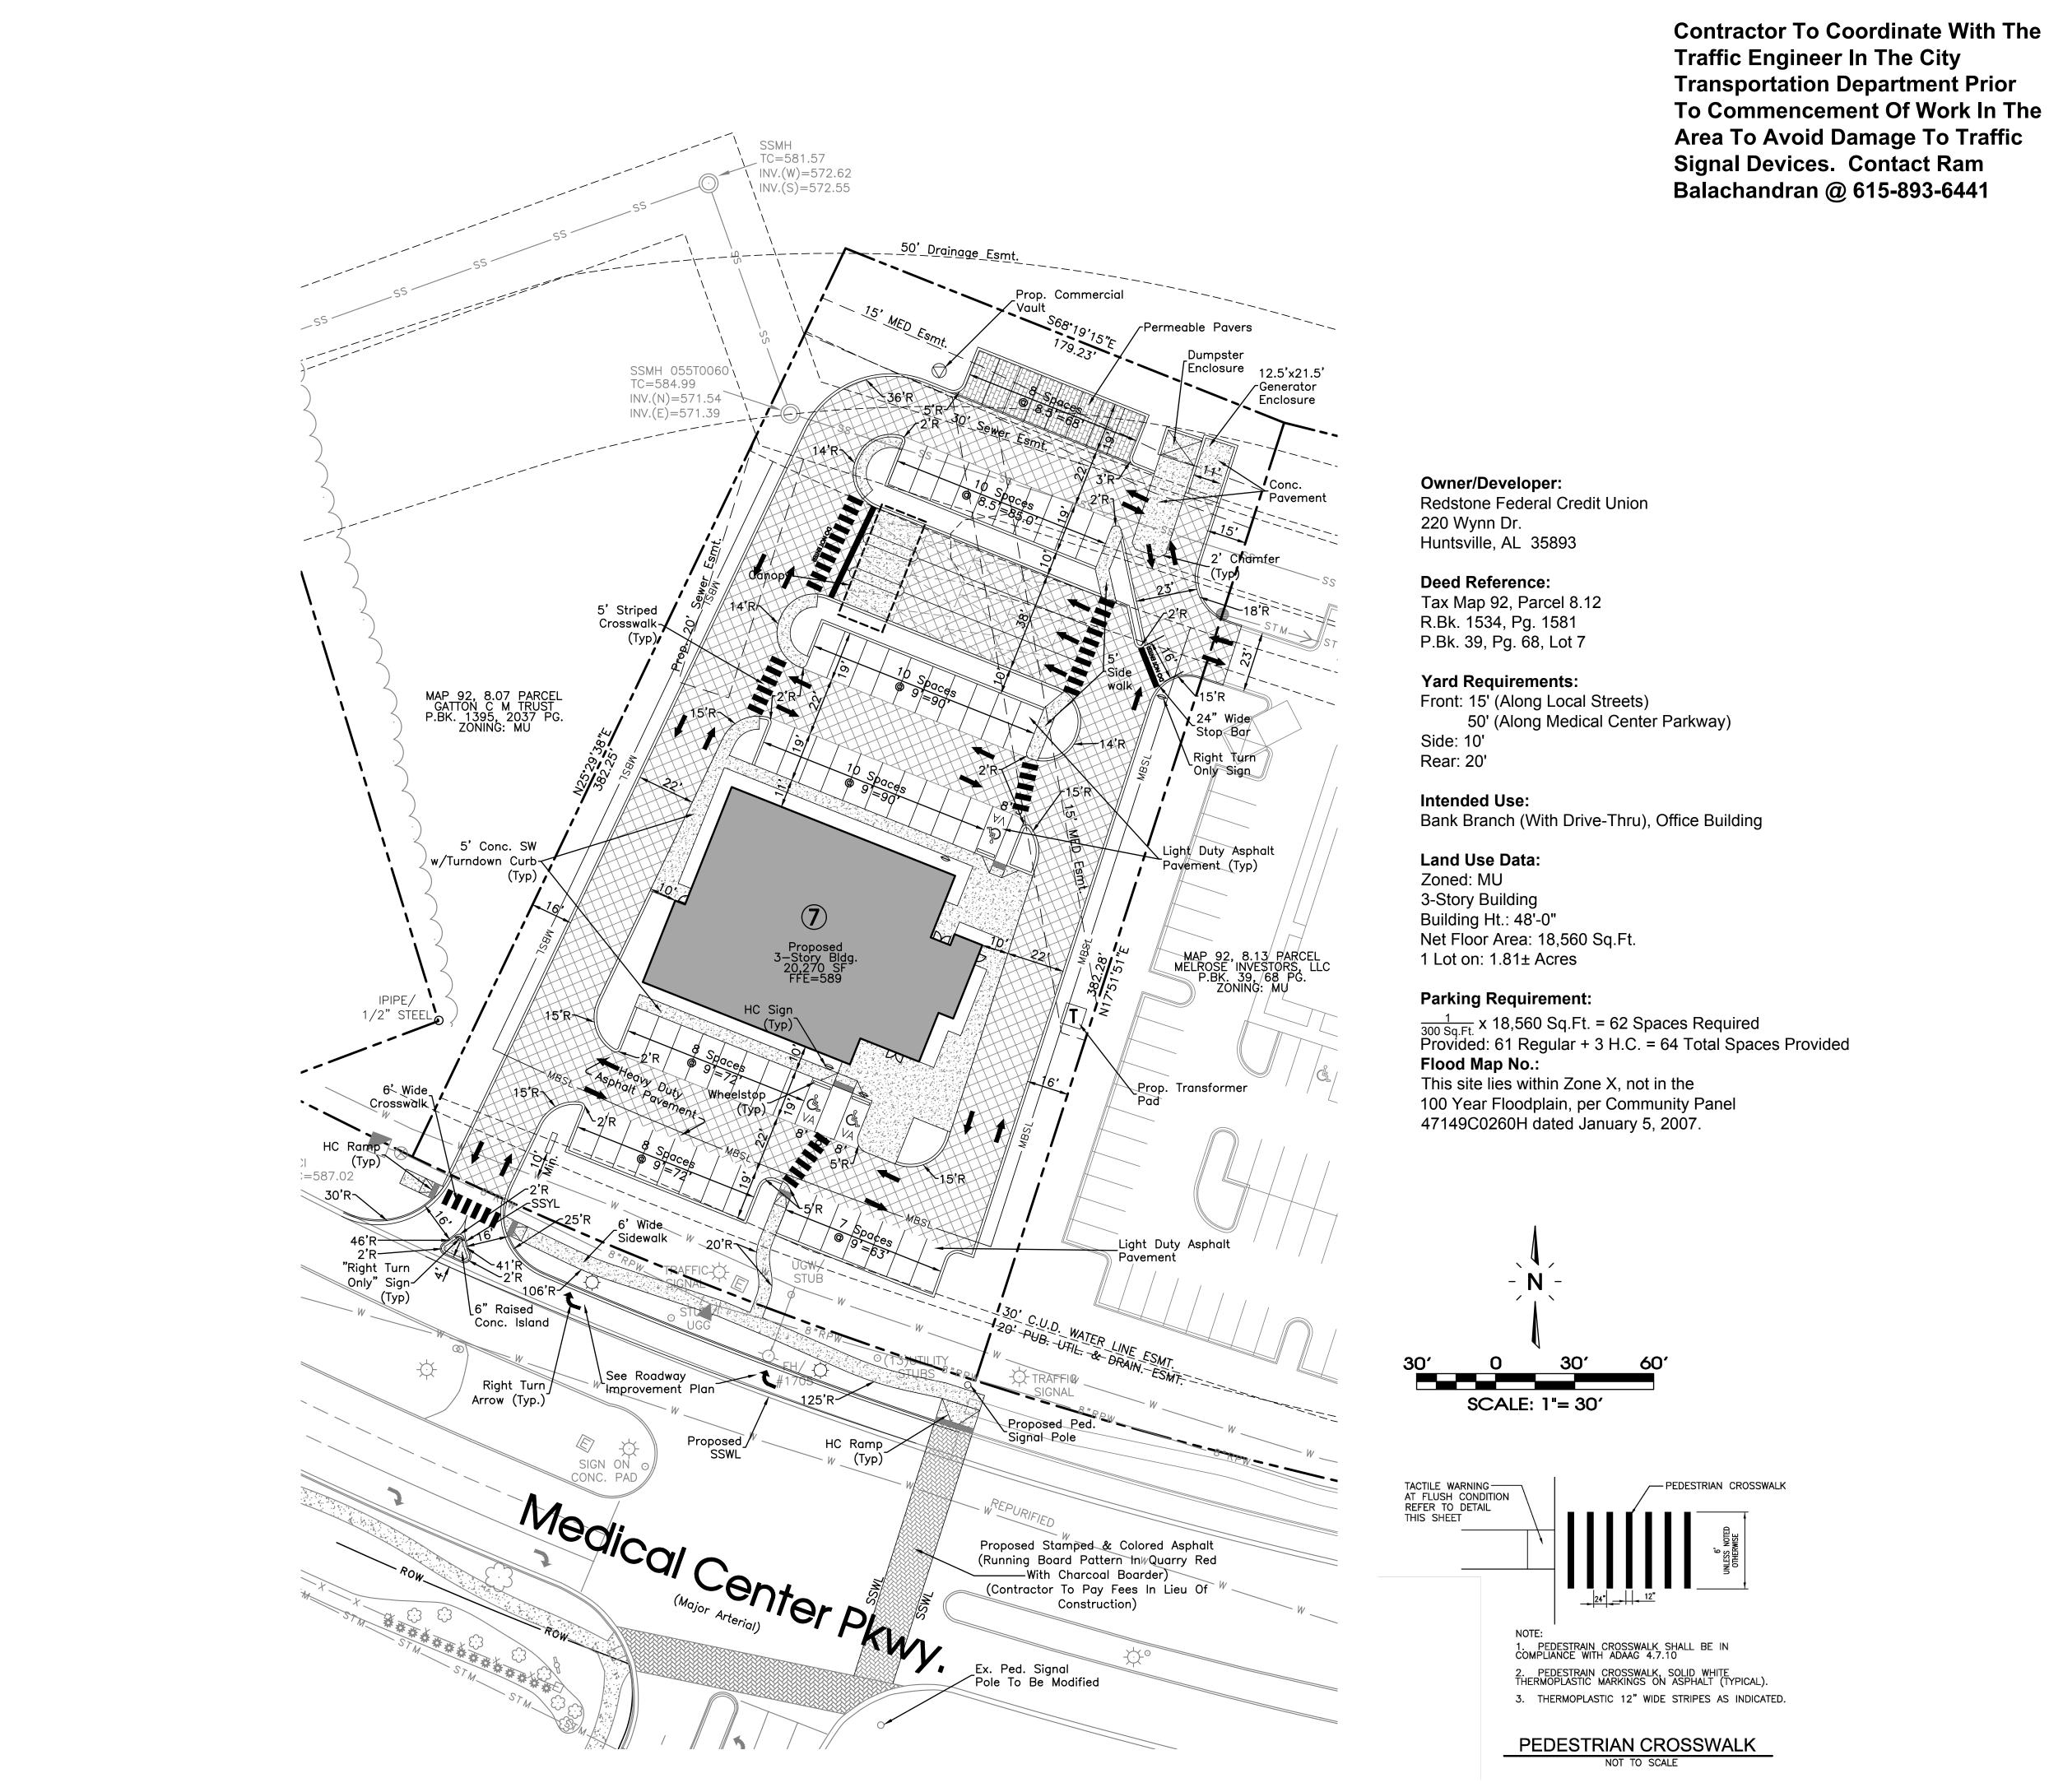

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SEC, Inc.

PROPOSED WATER

SITE ENGINEERING CONSULTANTS

ENGINEERING • SURVEYING • LAND PLANNING
LANDSCAPE ARCHITECTURE

850 MIDDLE TENNESSEE BOULEVARD MURFREESBORO, TENNESSEE 37129 NO PORTION OF THIS DRAWING MAY BE REPRODUCED WITHOUT THE EXPRESSED WRITTEN CONSENT OF S.E.C. INC. SEC Project #: 13260

DRAWING TITLE Site Plan DRAWN BY:

PROJECT STATUS

ISSUE DATE

REVISIONS No. Description

IDR Comments

FDR Comments

SCHEMATIC DESIGN

APRIL 21, 2017

1-22-18

2-20-18

NOT FOR CONSTRUCTION

Birmingham, AL 35233 205.251.0125

www.kpsgroup.com

The Architect shall not have control or charge of

precautions and programs in connection with the work, for the acts or omissions of the contractor, subcontractors or any other persons performing any of the work in accordance with the contract

This Drawing is an instrument of service and is the sole property of the Architect. Any use without the written consent of the Architect is prohibited.


PROJECT BRANCH OFFICE


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PROJECT NUMBER

CHECKED BY:

165026-02



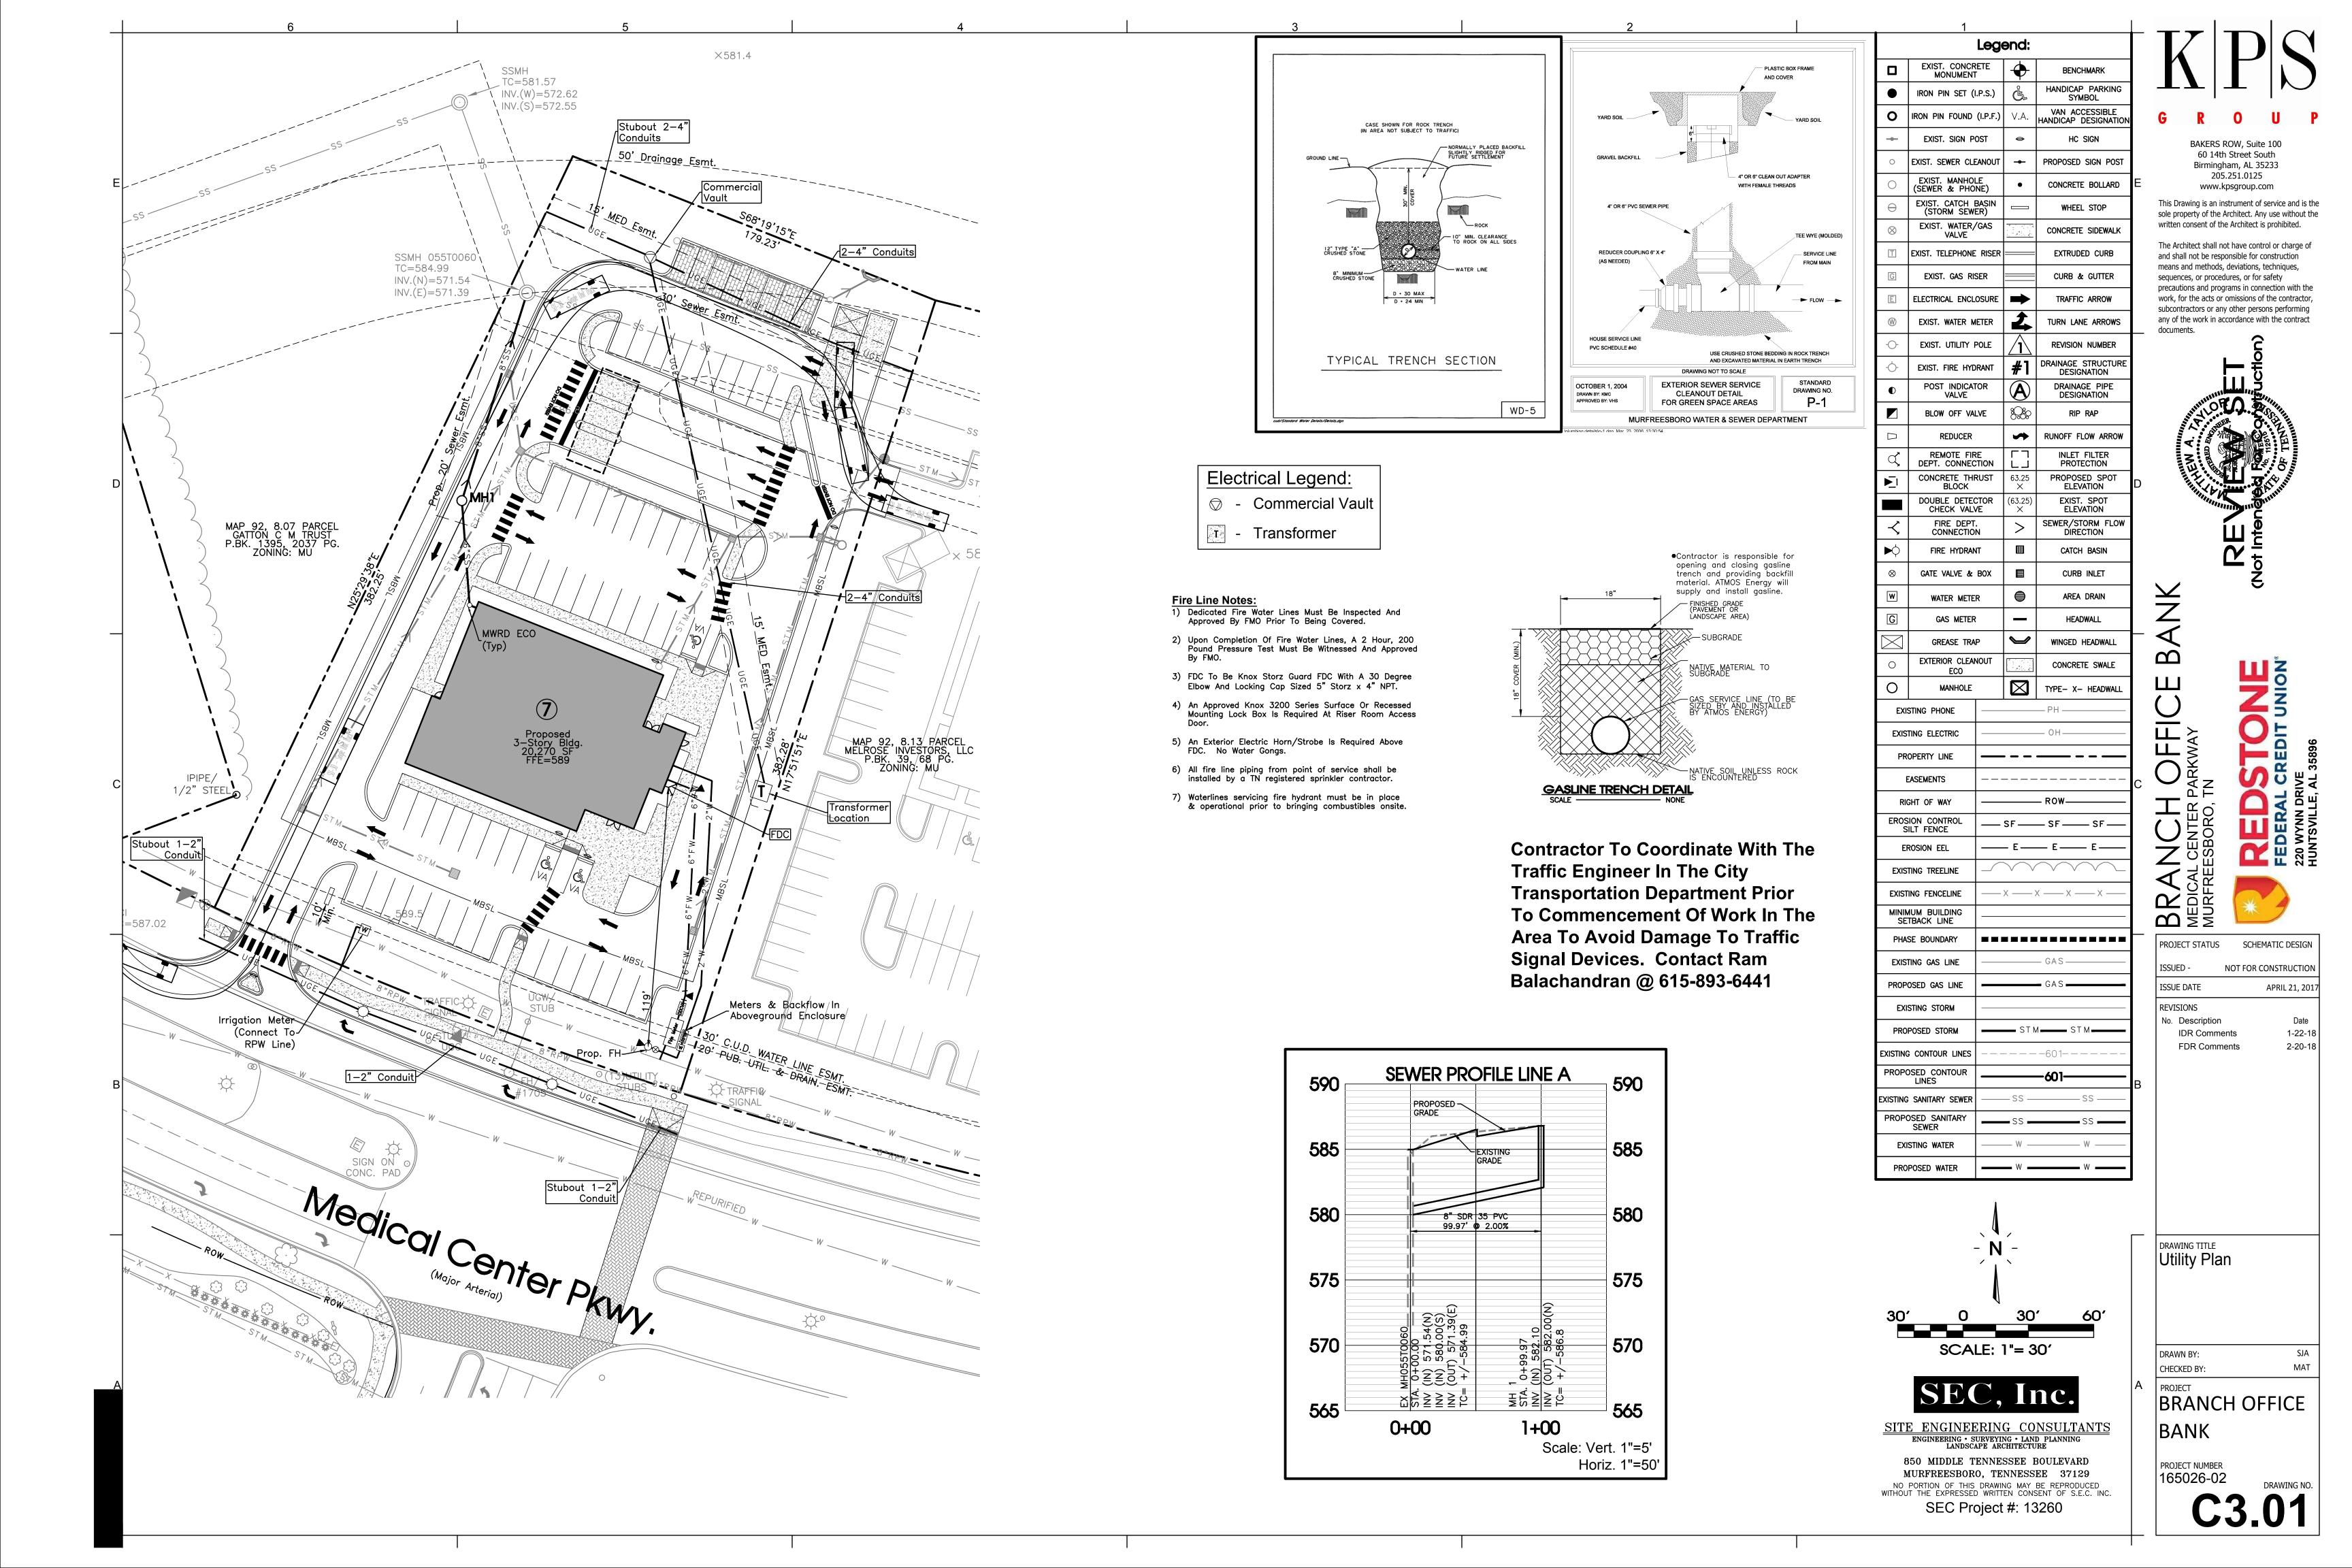

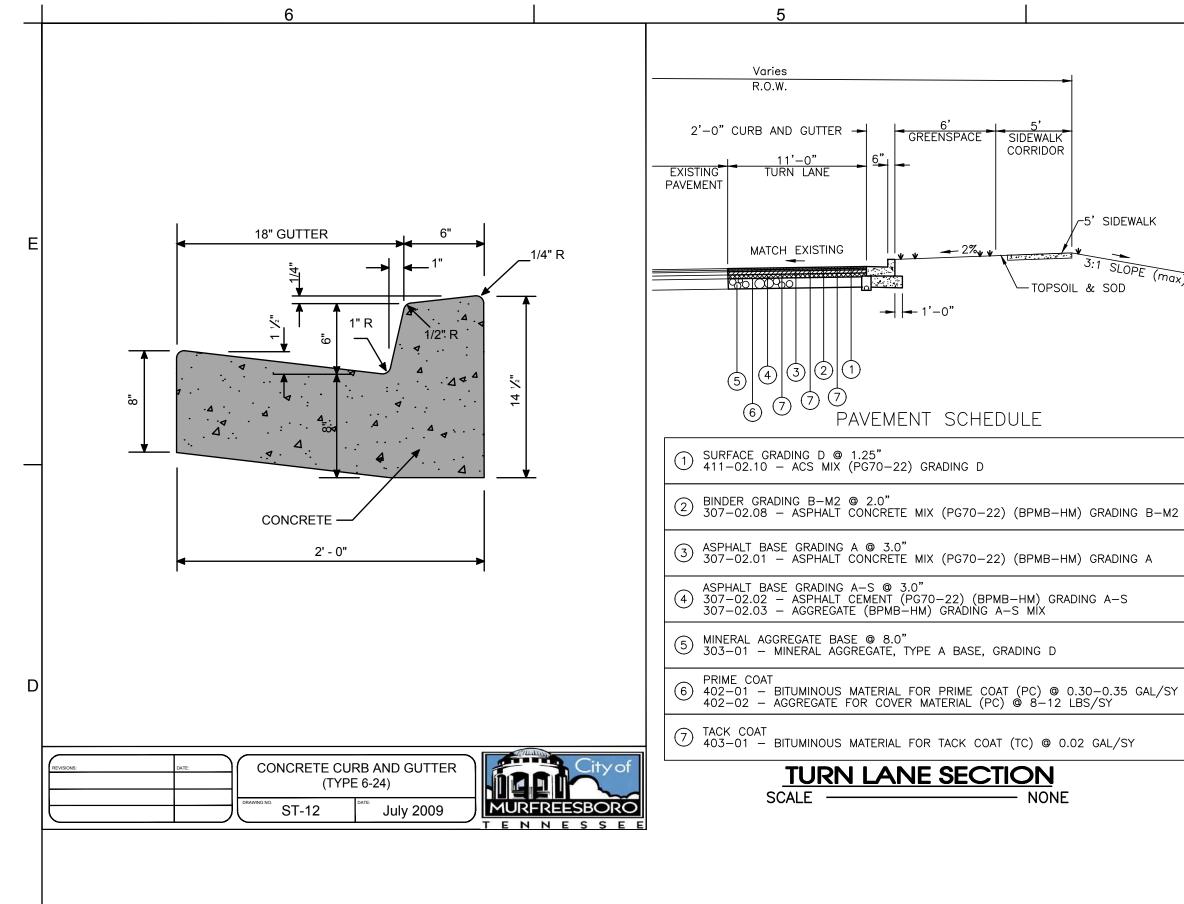THE CONTRACTOR SHALL SCHEDULE THE WORKS SO AS TO MINIMIZE

THE TIME TRAFFIC IS EXPOSED TO AN ELEVATION DIFFERENCE ONCE

OPERATION UNTIL THE CONDITION IS ELIMINATED.

SCALE

THE CONTRACTOR BEGINS AND ACTIVITY THAT CREATES AND ELEVATION DIFFERENCE. THE ACTIVITY SHALL BE PURSUED AS A CONTINUOUS

Contractor To Coordinate With The **Traffic Engineer In The City Transportation Department Prior** To Commencement Of Work In The **Area To Avoid Damage To Traffic** Signal Devices. Contact Ram Balachandran @ 615-893-6441

GREENSPACE SIDEWALK

PAVEMENT SCHEDULE

TURN LANE SECTION

-5' SIDEWALK

-TOPSOIL & SOD

TRAFFIC CONTROL

- ADVANCED WARNING SIGNS SHALL NOT BE DISPLAYED MORE THAN FORTY-EIGHT (48) HOURS BEFORE PHYSICAL CONSTRUCTION BEGINS. SIGNS MAY BE ERECTED UP ONE WEEK BEFORE NEEDED, IF THE SIGN FACE IS FULLY COVERED.
- IF THE CONTRACTOR MOVES OFF THE PROJECT, HE SHALL COVER OR REMOVE ALL UNNEEDED SIGNS AS DIRECTED BY THE ENGINEER. COSTS OF REMOVAL, COVERING REINSTALLING SIGNS SHALL NOT BE MEASURED AND PAID FOR SEPARATELY, BUT ALL COSTS SHALL BE INCLUDED IN THE ORIGINAL BID.
- A LONG TERM BUT SPORADIC USE WARNING SIGN, SUCH AS A FLAGGER SIGN, MAY REMAIN IN PLACE WHEN NOT REQUIRED PROVIDED THE SIGN FACE IS FULLY COV TRAFFIC CONTROL DEVICES SHALL NOT BE DISPLAYED OR ERECTED UNLESS RELATED CONDITIONS ARE PRESENT NECESSITATING WARNING
 - USE OF BARRICADES, PORTABLE BARRIER RAILS, VERTICAL PANELS, AND DRUMS SHALL BE LIMITED TO THE IMMEDIATE AREAS OF CONSTRUCTION WHERE A HAZARD PRESENT. THESE DEVICES SHALL NOT BE STORED ALONG THE ROADWAY WITHIN THIRTY (30) FEET OF THE EDGE OF THE TRAVELED WAY BEFORE OR AFTER USE UNLE PROTECTED BY GUARDRAIL, BRIDGE RAIL, AND/OR BARRIERS INSTALLED FOR OTHER PURPOSES. THESE DEVICES SHALL BE REMOVED FROM THE CONSTRUCTION WORK WHEN THE ENGINEER DETERMINES THEY ARE NO LONGER NEEDED. WHERE THERE IS INSUFFICIENT RIGHT-OF-WAY TO PROVIDE FOR THIS 30-FOOT SETBACK, THE
- THE CONTRACTOR SHALL NOT BE PERMITTED TO PARK ANY VEHICLES OR CONSTRUCTION EQUIPMENT DURING PERIODS OF INACTIVITY, WITHIN THIRTY (30) FEET OF THE OF PAVEMENT WHEN THE LANE IS OPEN TO TRAFFIC UNLESS PROTECTED BY GUARDRAIL, BRIDGE RAIL, AND/OR BARRIERS INSTALLED FOR OTHER PURPOSES. PRIVATEL OWNED VEHICLES SHALL NOT BE ALLOWED TO PARK WITHIN THIRTY (30) FEET OF AN OPEN TRAFFIC LANE AT ANY TIME UNLESS PROTECTED AS DESCRIBED ABOVE. W THERE IS INSUFFICIENT RIGHT-OF-WAY TO PROVIDE FOR THIS 30-FOOT SETBACK, THE CONTRACTOR SHALL DETERMINE THE ALTERNATE LOCATIONS AND REQUEST THE
- ENGINEER'S APPROVAL TO USE THEM. ALL DETOUR AND CONSTRUCTION SIGNING SHALL BE IN STRICT ACCORDANCE WITH THE MANUAL ON UNIFORM TRAFFIC CONTROL DEVICES
- THIS SET OF PLANS IS NOT INTENDED TO SUPERSEDE OR RELIEVE THE CONTRACTOR OF ANY RESPONSIBILITY TOWARD MOTORISTS, PEDESTRIANS OR PROPERTY OWNERS WITHIN THE CONSTRUCTION LIMITS.
- THIS PLAN IS TO SERVE AS A GUIDE ONLY. OTHER SIGNS MAY BE REQUIRED DURING VARIOUS PHASES OF CONSTRUCTION. ALL REGULATORY AND WARNING SIGNS W ARE NO LONGER APPROPRIATE BECAUSE OF THE CONSTRUCTION SHALL BE COVERED OR REMOVED
- THE APPROPRIATE TRAFFIC CONTROL SHALL BE INSTALLED AT THE INCEPTION OF EACH STAGE OF CONSTRUCTION AND SHALL BE PROPERLY MAINTAINED AND/OR OPERA DURING THE TIME SUCH SPECIAL CONDITIONS EXIST. THEY SHALL REMAIN IN PLACE ONLY AS LONG AS THEY ARE NEEDED AND SHALL BE IMMEDIATELY REMOVED.
 - DEVICES AND SHALL COMPLY WITH THE STATE OF TENNESSEE DEPARTMENT OF TRANSPORTATION, BUREAU OF HIGHWAYS, STANDARD SPECIFICATIONS FOR ROAD AND BRI CONSTRUCTION SECTION 712 - TEMPORARY TRAFFIC CONTROL
- BARRICADE WARNING LIGHTS SHALL BE ACCORDANCE WITH THE REQUIREMENTS OF THE STANDARD FOR FLASHING AND STEADY BURN BARRICADE WARNING LIGHTS 1978.
- (13) AT ALL TIMES THE ROADWAY MUST BE MAINTAINED IN A CONDITION TO ALLOW THE PASSAGE OF EMERGENCY VEHICLES AND THEIR ACCESS TO RESIDENCES/BUSINESSES THROUGHOUT THE CONSTRUCTION ZONE.
- (14) FLEXIBLE DRUMS FOR CHANNELIZING TRAFFIC ARE TO BE PROVIDED AS SHOWN OR AS REQUIRED BY THE ENGINEER.


CONTRACTOR SHALL DETERMINE THE ALTERNATE LOCATIONS AND REQUEST THE ENGINEER'S APPROVAL TO USE THEM.

- (15) DURING CONSTRUCTION ALL TRAVEL LANES (PERMANENT OR TEMPORARY) SHALL BE A MINIMUM OF TEN (10) FEET IN WIDTH AND SHALL INCLUDE ALL SIGNING IN ACCORDANCE WITH THE CONSTRUCTION DOCUMENTS
- THE TRAFFIC CONTROL PLAN AS SHOWN SHALL BE CONSIDERED AS A MINIMUM. OTHER DEVICES MAY BE REQUIRED AS DIRECTED BY THE ENGINEER OR AS DIRECTED BY THE MANUAL ON UNIFORM TRAFFIC CONTROL DEVICES
- (17) ALL SIGNS, BARRICADES AND WARNING LIGHTS SHALL CONFORM WITH SECTION VI OF THE MANUAL ON UNIFORM TRAFFIC CONTROL DEVICES (MUTCD).
- (18) ALL TRAFFIC CONTROL DEVICES SHALL BE REMOVED IMMEDIATELY UPON COMPLETION OF THE PROJECT ANY TEMPORARY OR PERMANENT PAVEMENT MARKINGS SHALL BE FIRST APPROVED BY THE CITY TRAFFIC ENGINEER.
- THE CONTRACTOR SHALL COMPLY WITH SECTION 712 REGARDING TEMPORARY TRAFFIC CONTROL OF THE "STANDARD SPECIFICATIONS FOR ROAD AND BRIDGE CONSTRUCT IN THE IMPLEMENTATION OF THE TRAFFIC CONTROL PLAN. TEMPORARY CENTERLINE AND LANE MARKING SHALL BE PROVIDED AT THE CONCLUSION OF EACH WORK DAY DURING THE RESURFACING PORTION OF THIS PROJECT
- ANY LANE CLOSURES SHALL BE SIGNED IN ACCORDANCE WITH SECTION VI OF MUTCD.
- LANE CLOSURES INVOLVING MORE THAN ONE THROUGH LANE AT A TIME SHALL BE APPROVED BY THE CITY ENGINEER THE CONTRACTOR IS DIRECTLY RESPONSIBLE FOR THE PROVISION OF ANY AND ALL TRAFFIC CONTROL DEVICES IN ACCORDANCE WITH MUTCD AND SECTION 712 OF THE
- STANDARD SPECIFICATIONS FOR ROAD AND BRIDGE CONSTRUCTION.
- (24) ALL TRAFFIC CONTROL DEVICES SHALL BE REMOVED IMMEDIATELY UPON COMPLETION OF THE PORTION OF THE PROJECT. DURING CONSTRUCTION, CONTRACTOR SHALI
- FOLLOW T.D.O.T.'S "GUIDELINES FOR HANDLING DIFFERENCES IN ELEVATION BETWEEN ADJACENT ROADWAY ELEMENTS"
- (25) IF THE DIFFERENCE IN ELEVATION IS WITHIN 8 FEET OF THE NEAREST TRAFFIC LANE WITH DIFFERENCE IN ELEVATION GREATER THAN 6 INCHES. A) SEPARATION SHALL BE ACCOMPLISHED BY DRUMS, BARRICADES OR OTHER APPROVED DEVICES IN ACCORDANCE WITH THE FOLLOWING.
 - 1) WHERE POSTED SPEEDS ARE 50 MPH OR GREATER, SPACING OF THE PROTECTIVE DEVICES SHALL NOT EXCEED 100 FEET.
 - 2) WHERE POSTED SPEEDS ARE LESS THAN 50 MPH. THE MAXIMUM SPACING OF THE PROTECTIVE DEVICES IN FEET SHALL NOT EXCEED TWICE THE POSTED SPEE IN MILES PER HOUR OR 50 FEET, WHICHEVER SPACING IS GREATER.
- B) ELIMINATE VERTICAL OFFSET BY CONSTRUCTING A STONE WEDGE OR GRADING TO A 4:1 SLOPE, OR FLATTER, OR USE PORTABLE BARRIER RAIL. THE CONTRACTOR SHALL SCHEDULE THE WORK SO AS TO MINIMIZE THE TIME TRAFFIC IS EXPOSED TO AN ELEVATION DIFFERENCE. ONCE THE CONTRACTOR BEGINS AN ACTIVITY THA CREATES AN ELEVATION DIFFERENCE WITHIN 8 FEET OF A TRAFFIC LANE, THE ACTIVITY SHALL BE PURSUED AS A CONTINUOUS OPERATION UNTIL THE ELEVATION
- PRIOR TO CLOSING ANY ROAD TO THROUGH TRAFFIC, THE CONTRACTOR WILL BE REQUIRED TO NOTIFY ALL AFFECTED LOCAL AGENCIES CONCERNING THE ROAD CLOSUR THE AGENCIES TO BE CONTACTED SHALL INCLUDE BUT NOT BE LIMITED TO THE FOLLOWING: FIRE DEPT., SHERIFFS DEPT., POST OFFICE, BOARD OF EDUCATION, ETC.
- SIGNAGE SHALL COMPLY WITH M.U.T.C.D. AND WITH T.D.O.T. STD. DWGS. T-M-1 THROUGH T-M-4.
- TRENCHES IN STREETS TEMPORARILY REOPENED TO TRAFFIC SHALL BE MAINTAINED AND SURFACED WITH COLD MIX OR BINDER UNTIL FINAL CONSTRUCTION.
- THE CONTRACTOR MAY DEVELOP AN ALTERNATE TRAFFIC CONTROL PLAN IF APPROVED BY THE CITY TRAFFIC DEPT AND CITY ENGINEER. ACCESS TO PROPERTY WITHIN CONSTRUCTION LIMITS SHALL BE MAINTAINED AT ALL TIMES DURING CONSTRUCTION.
- CONTRACTOR SHALL FURNISH FLAGGER(S) AS NECESSARY.
- THESE PLANS ARE NOT INTENDED TO SUPERSEDE OR RELIEVE THE CONTRACTOR OF ANY RESPONSIBILITY TOWARD MOTORISTS OR PROPERTY OWNERS WITHIN CONSTRUCT
- LIMITS OR TOWARD INSTALLING TRAFFIC CONTROL DEVICES IN ACCORDANCE WITH CURRENT M.U.T.C.D. REQUIREMENTS. (33) ALL PAVEMENT STRIPING IN PUBLIC RIGHT-OF-WAY TO BE THERMOPLASTIC.

NOTES:


COORDINATE ALL PAVEMENT MARKINGS WITH THE CITY TRAFFIC ENGINEER CONTACT THE ENGINEERING DEPT. 24 HRS PRIOR TO BEGINNING FOR APPROVAL OF LINE LOCATION.

LANE CLOSURES WILL ONLY BE ALLOWED DURING THE HOURS OF 8:30AM AND 3:30PM. COORDINATE ANY CLOSURE WITH THE CITY TRAFFIC ENGINEER.

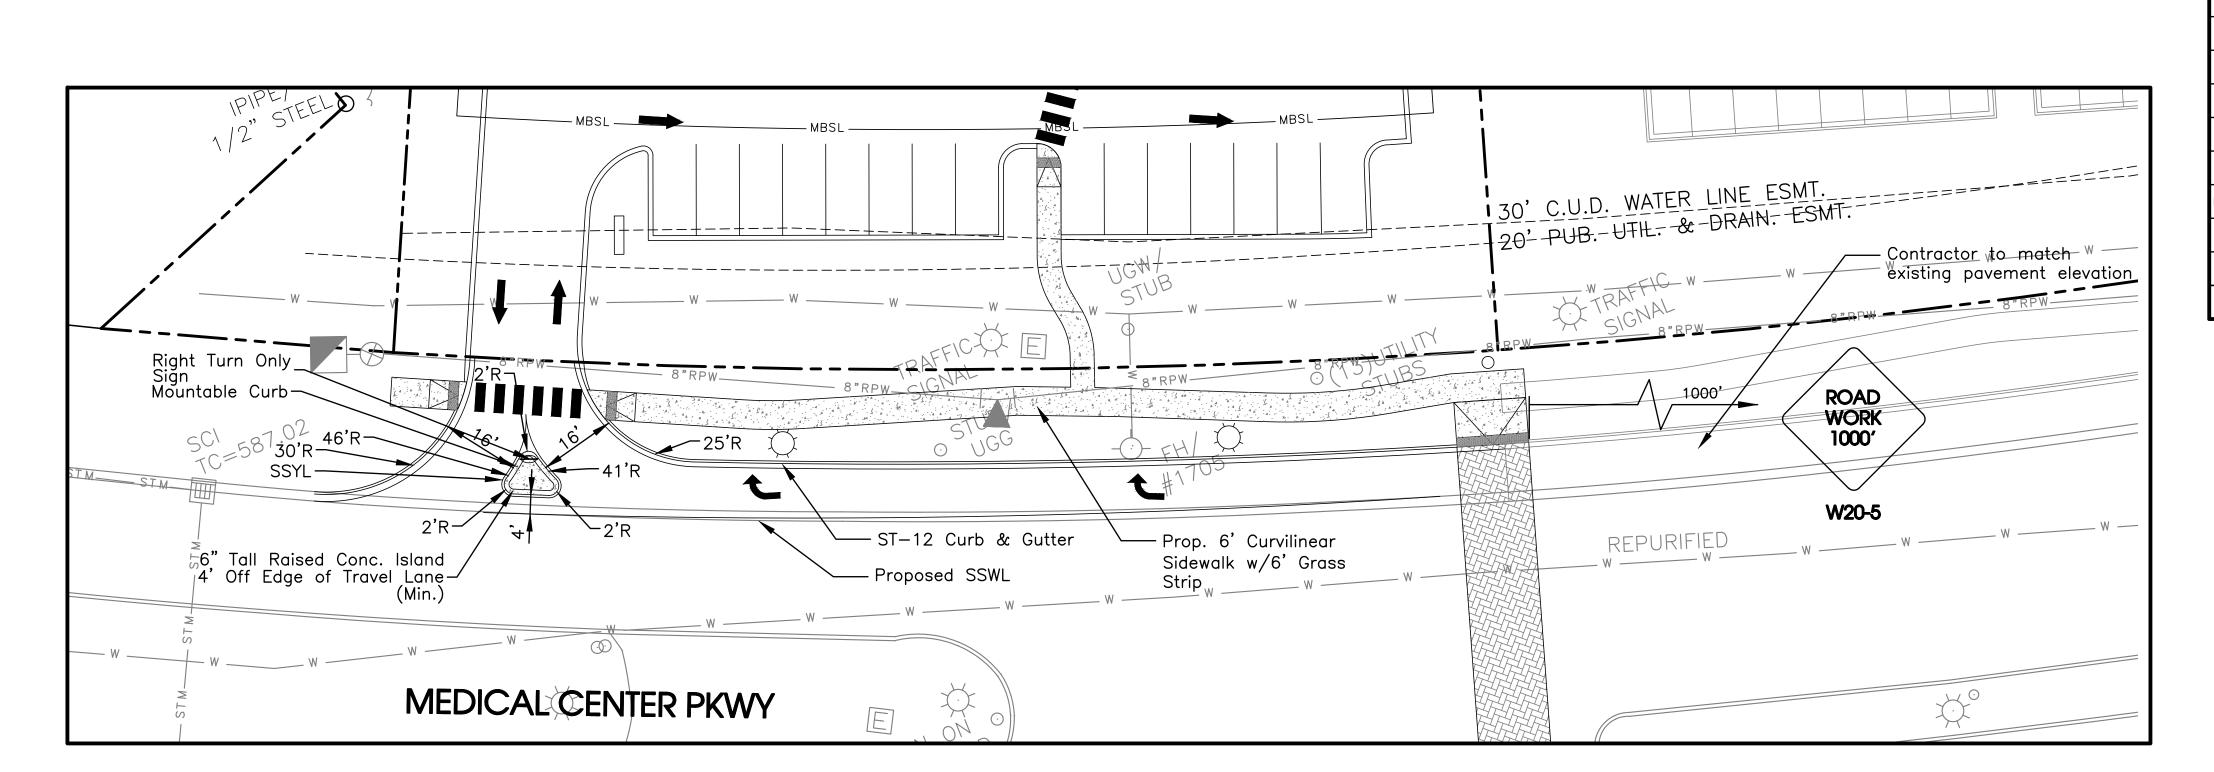

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PHASE BOUNDARY PROJECT STATUS EXISTING GAS LINE ISSUED -PROPOSED GAS LINE ISSUE DATE **REVISIONS** EXISTING STORM PROPOSED STORM EXISTING CONTOUR LINES PROPOSED CONTOUR EXISTING SANITARY SEWER PROPOSED SANITARY PROPOSED WATER

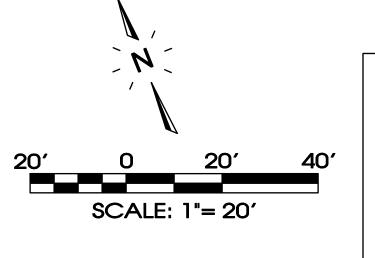

SEC, Inc.

SITE ENGINEERING CONSULTANTS ENGINEERING • SURVEYING • LAND PLANNING LANDSCAPE ARCHITECTURE 850 MIDDLE TENNESSEE BOULEVARD MURFREESBORO, TENNESSEE 37129 NO PORTION OF THIS DRAWING MAY BE REPRODUCED WITHOUT THE EXPRESSED WRITTEN CONSENT OF S.E.C. INC.

SEC Project #: 13260

DRAWING TITLE Offsite Improvement

SCHEMATIC DESIGN

APRIL 21, 201

1-22-18

2-20-18

NOT FOR CONSTRUCTION

BAKERS ROW, Suite 100

60 14th Street South

Birmingham, AL 35233

205.251.0125

www.kpsgroup.com

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and shall not be responsible for construction means and methods, deviations, techniques

sequences, or procedures, or for safety

documents.

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The Architect shall not have control or charge of

precautions and programs in connection with th

work, for the acts or omissions of the contracto

subcontractors or any other persons performing

any of the work in accordance with the contract

DRAWN BY: CHECKED BY

No. Description


IDR Comments

FDR Comments

PROJECT **BRANCH OFFICE** BANK

PROJECT NUMBER 165026-02

DRAWING NO.

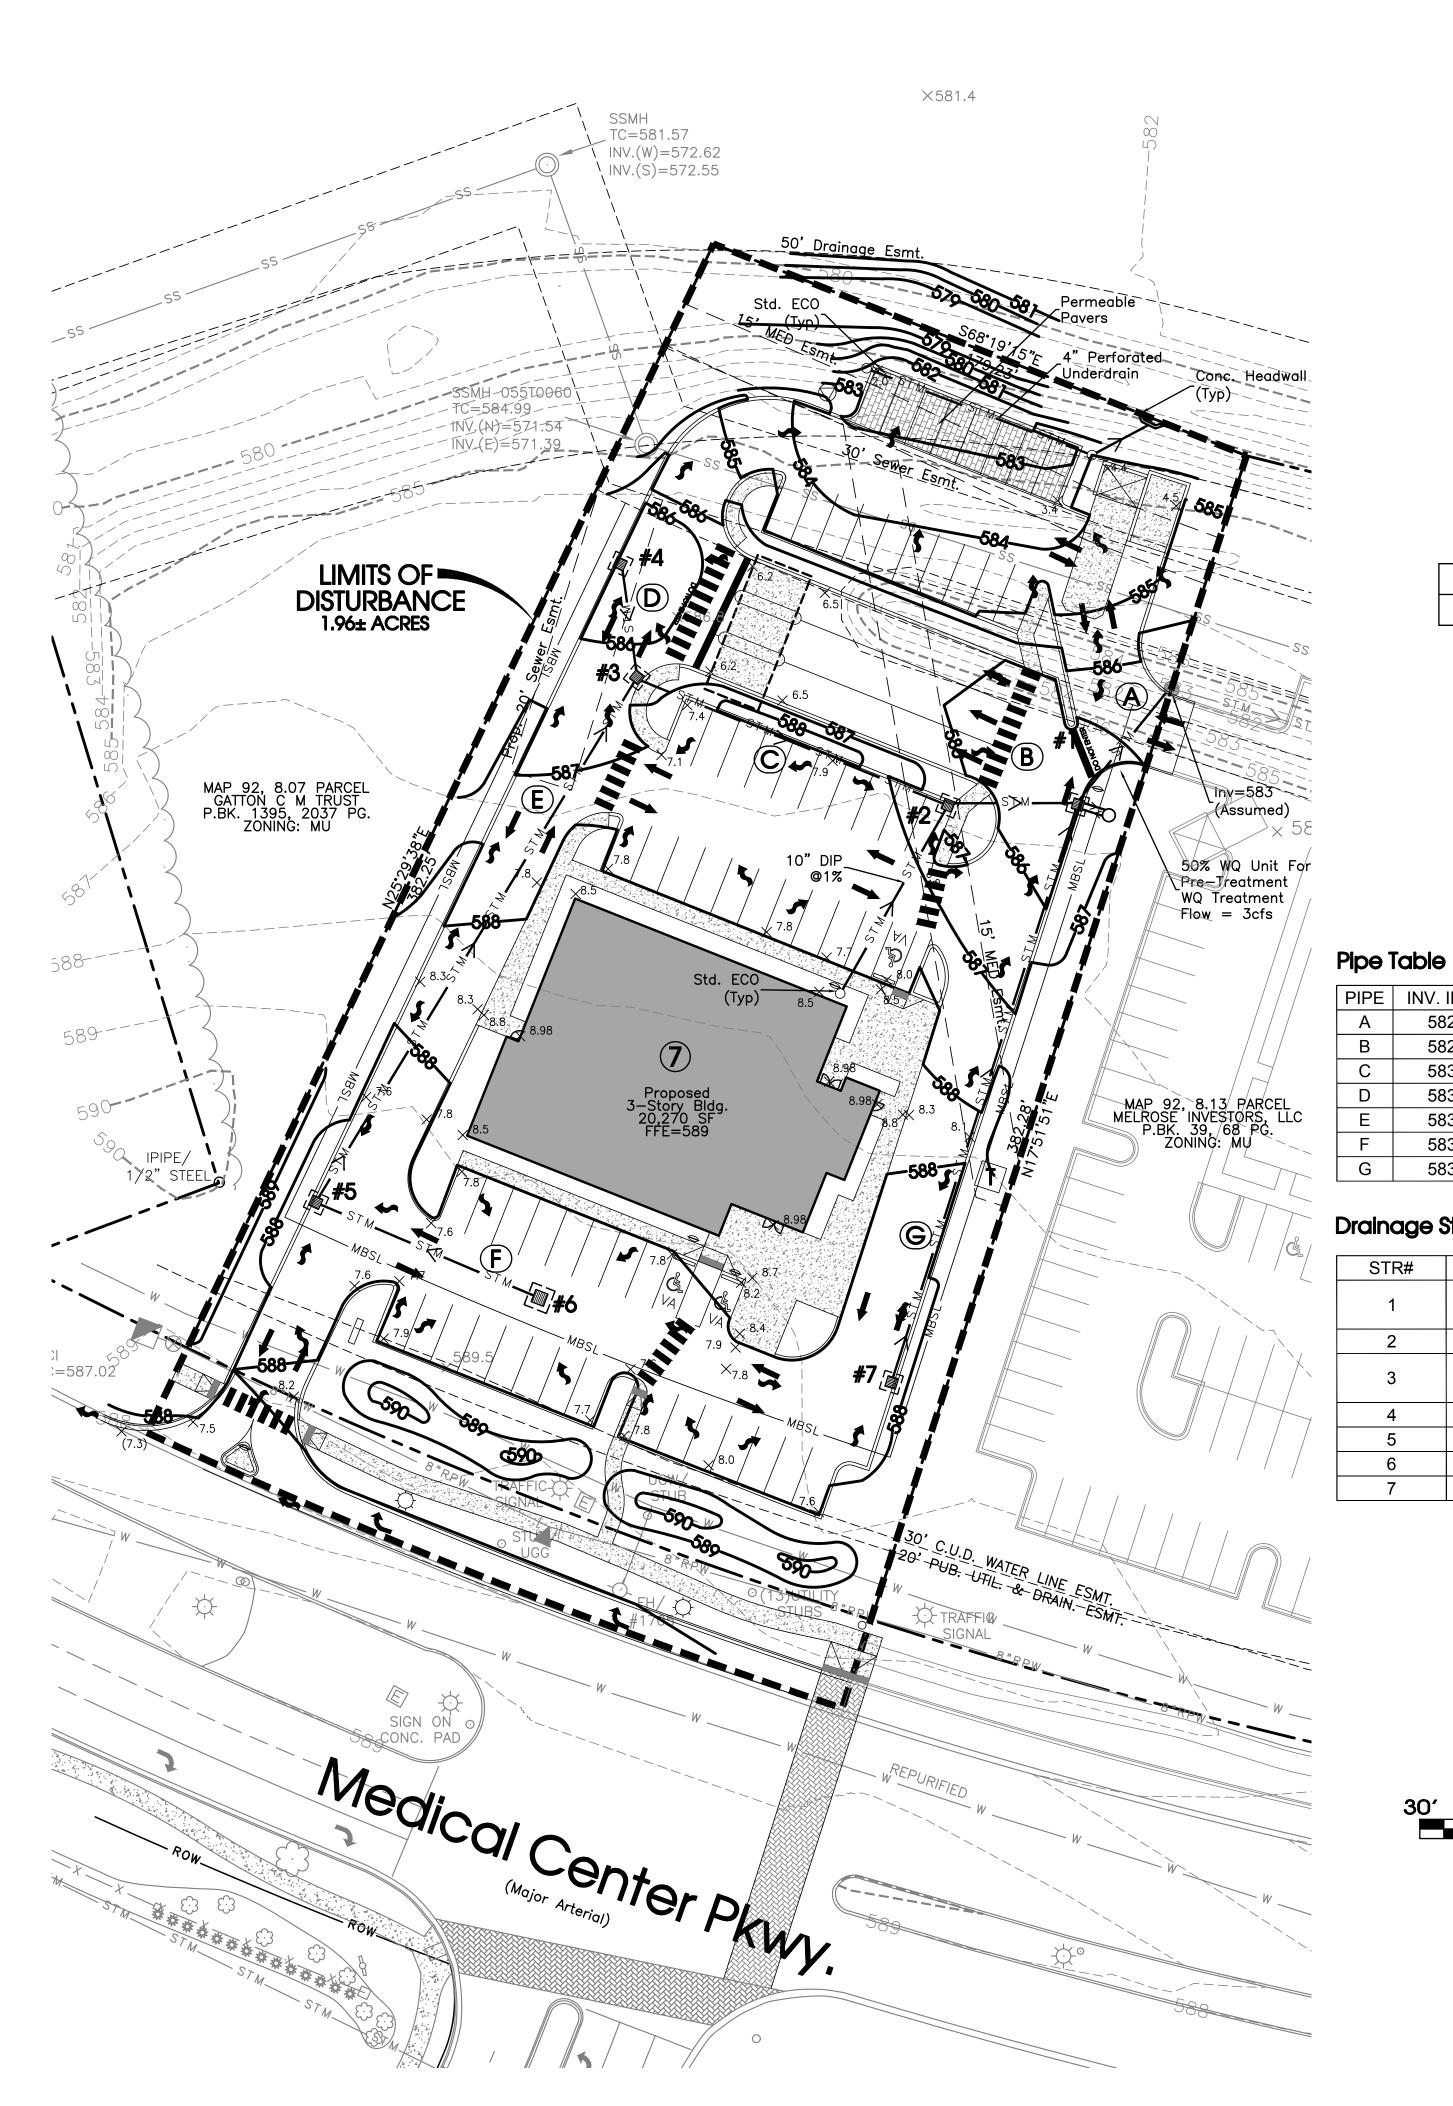

Contractor To Coordinate With The Traffic Engineer In The City **Transportation Department Prior** To Commencement Of Work In The **Area To Avoid Damage To Traffic** Signal Devices. Contact Ram Balachandran @ 615-893-6441

FINAL OUTFALLS		
DESCRIPTION	AREA	SLOPE
BOX CULVERT At N.W. CORNER		1-5%

PIPE	INV. IN (FT)	INV. OUT (FT)	LENGTH (FT)	SLOPE (%)	MATERIAL	SIZE (IN)
Α	582.60	582.50	33	0.30	RCP	24
В	582.74	582.60	47	0.30	RCP	18
С	583.05	582.74	105	0.30	RCP	15
D	583.16	583.05	36	0.30	RCP	15
Е	583.63	583.05	192	0.30	RCP	15
F	583.86	583.63	76	0.30	RCP	15
G	583.22	582.60	205	0.30	RCP	15

Drainage Structures Table

STR#	T.O.C	INV. IN (FT)	INV. OUT (FT)	CASTING	TYPE
1	585.50	582.60(B) 582.60(G)	582.6	JBS 4075	Catch Basin
2	586.80	582.74	582.74	JBS 3104	Single Curb Inlet
3	586.40	583.05(D) 583.05(E)	583.05	JBS 4075	Catch Basin
4	585.50	N/A	583.16	JBS 3104	Single Curb Inlet
5	587.20	583.63	583.63	JBS 3104	Single Curb Inlet
6	587.30	N/A	583.86	JBS 4075	Catch Basin
7	587.30	N/A	583.22	JBS 4075	Catch Basin

	0	IRON PIN FOUND (I.P.F.)	V.A.	VAN ACCESSIBLE HANDICAP DESIGNATION		G	R	0	U	P	
•	+	EXIST. SIGN POST	0	HC SIGN			BAKERS	ROW, S	uite 100		
l	0	EXIST. SEWER CLEANOUT	-	PROPOSED SIGN POST			Birming	th Street gham, AL	35233		
	0	EXIST. MANHOLE (SEWER & PHONE)	•	CONCRETE BOLLARD	E			5.251.01 .kpsgrou			
	\bigcirc	EXIST. CATCH BASIN (STORM SEWER)		WHEEL STOP					t of service and Any use with		
	\otimes	EXIST. WATER/GAS VALVE	**************************************	CONCRETE SIDEWALK					ct is prohibited		
	T	EXIST. TELEPHONE RISER		EXTRUDED CURB		and shal	I not be res	sponsible f	ontrol or chargor or construction	1	
	G	EXIST. GAS RISER		CURB & GUTTER		sequenc	es, or proc	edures, or	ns, techniques for safety connection wit		
	E	ELECTRICAL ENCLOSURE		TRAFFIC ARROW		work, fo	r the acts o	r omission	is of the contra ersons perforn	ictor,	
	(W)	EXIST. WATER METER	4	TURN LANE ARROWS			ne work in a		e with the cont		
	\Diamond	EXIST. UTILITY POLE		REVISION NUMBER					Š		
		EXIST. FIRE HYDRANT	#1	DRAINAGE STRUCTURE DESIGNATION					₹		
	•	POST INDICATOR VALVE	A	DRAINAGE PIPE DESIGNATION			111111		Ž,,,,		
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Legend:

BENCHMARK

HANDICAP PARKING SYMBOL

EXIST. CONCRETE MONUMENT

SCALE: 1"= 30'

1) Final EPSC Measures Shown Here On Shall Be Enacted As Early As Practical During Construction. Stabilization Timing Criteria Has Been Established In The SWPPP and TNCGP.

2) Inlet Protection, Erosion Blanket & Temporary Stabilization (I.E. Seed & Mulch) Will Be installed By General Contractor. Permanent Stabilization Measure (I.E. Sod, Landscape, Pavement) Will Be Installed By Owner.)

SEC, Inc.

SITE ENGINEERING CONSULTANTS

ENGINEERING • SURVEYING • LAND PLANNING
LANDSCAPE ARCHITECTURE 850 MIDDLE TENNESSEE BOULEVARD MURFREESBORO, TENNESSEE 37129 NO PORTION OF THIS DRAWING MAY BE REPRODUCED WITHOUT THE EXPRESSED WRITTEN CONSENT OF S.E.C. INC. SEC Project #: 13260


Grading, Drainage & Final EPSC Plan

DRAWN BY: CHECKED BY:

PROJECT BRANCH OFFICE

BANK

PROJECT NUMBER 165026-02

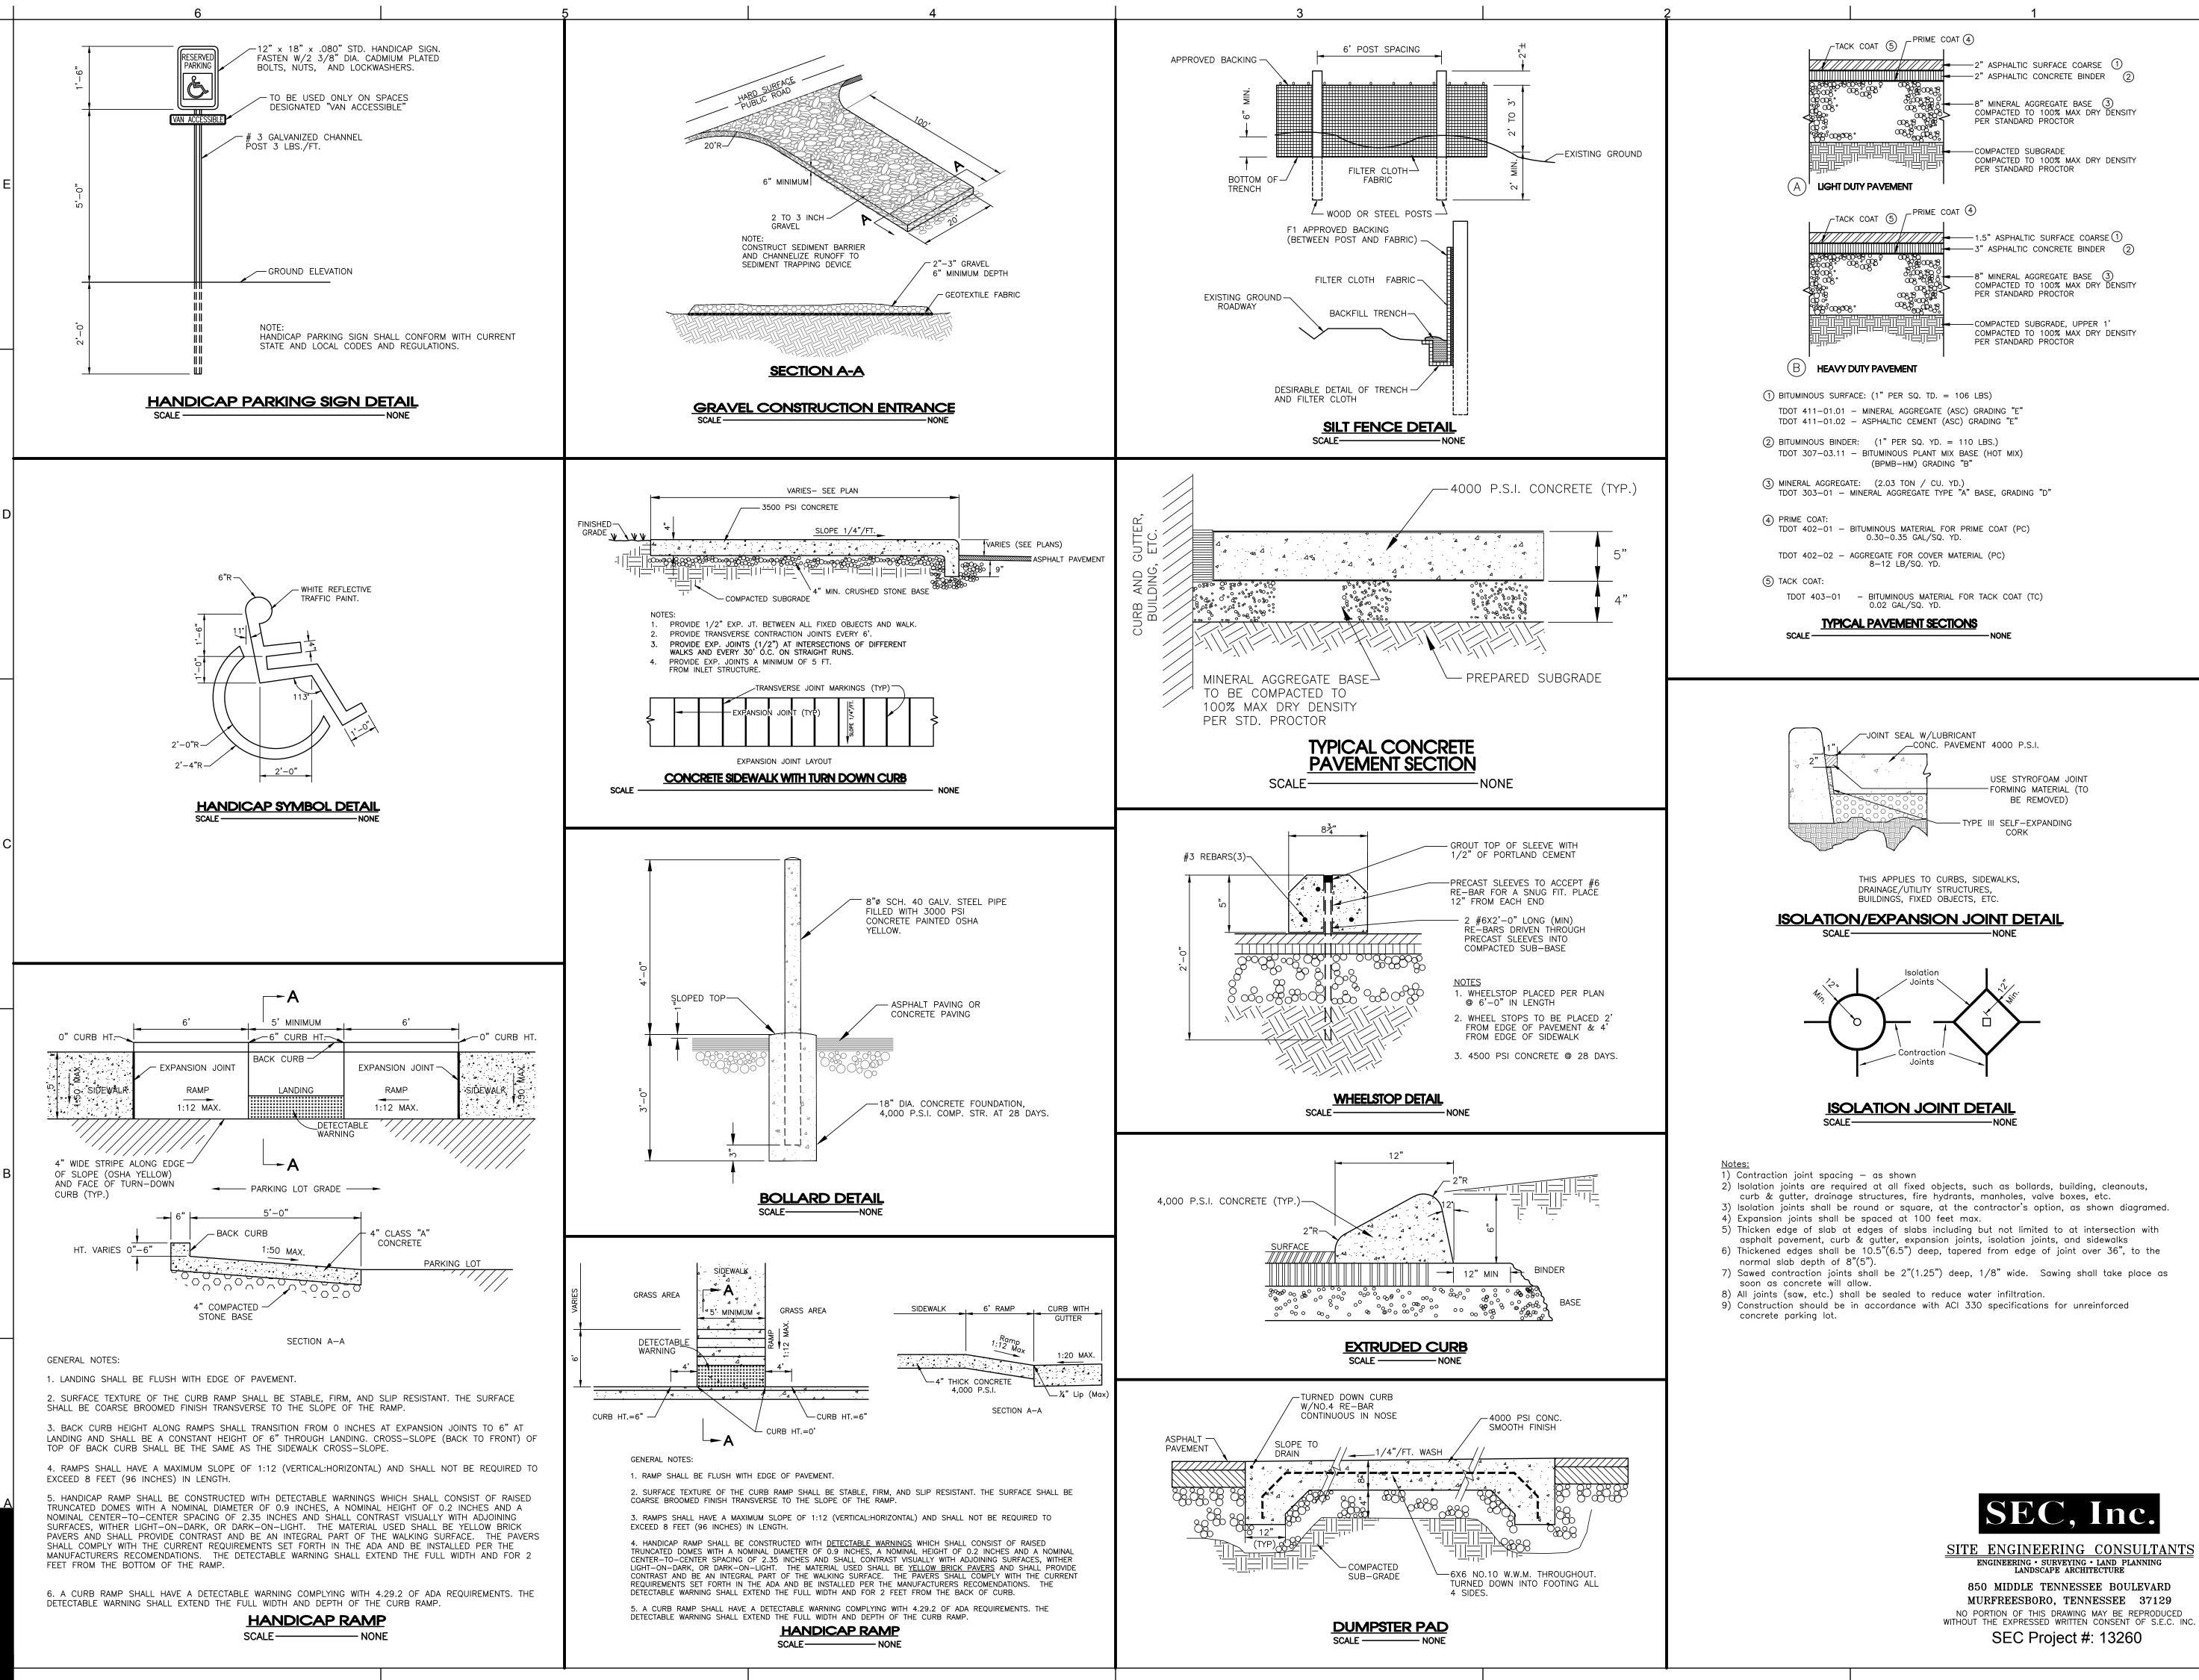

BAKERS ROW, Suite 100 60 14th Street South Birmingham, AL 35233 205.251.0125

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means and methods, deviations, techniques, sequences, or procedures, or for safety precautions and programs in connection with the work, for the acts or omissions of the contractor, subcontractors or any other persons performing any of the work in accordance with the contract documents.

SITE ENGINEERING CONSULTANTS 850 MIDDLE TENNESSEE BOULEVARD

BANK PROJECT NUMBER

 \square PROJECT STATUS SCHEMATIC DESIGN ISSUED -NOT FOR CONSTRUCTION ISSUE DATE APRIL 21, 2017 REVISIONS No. Description

1-22-18 **IDR Comments** 2-20-18 FDR Comments


DRAWING TITLE Details

DRAWN BY:

CHECKED BY:

PROJECT **BRANCH OFFICE**

165026-02 DRAWING NO.

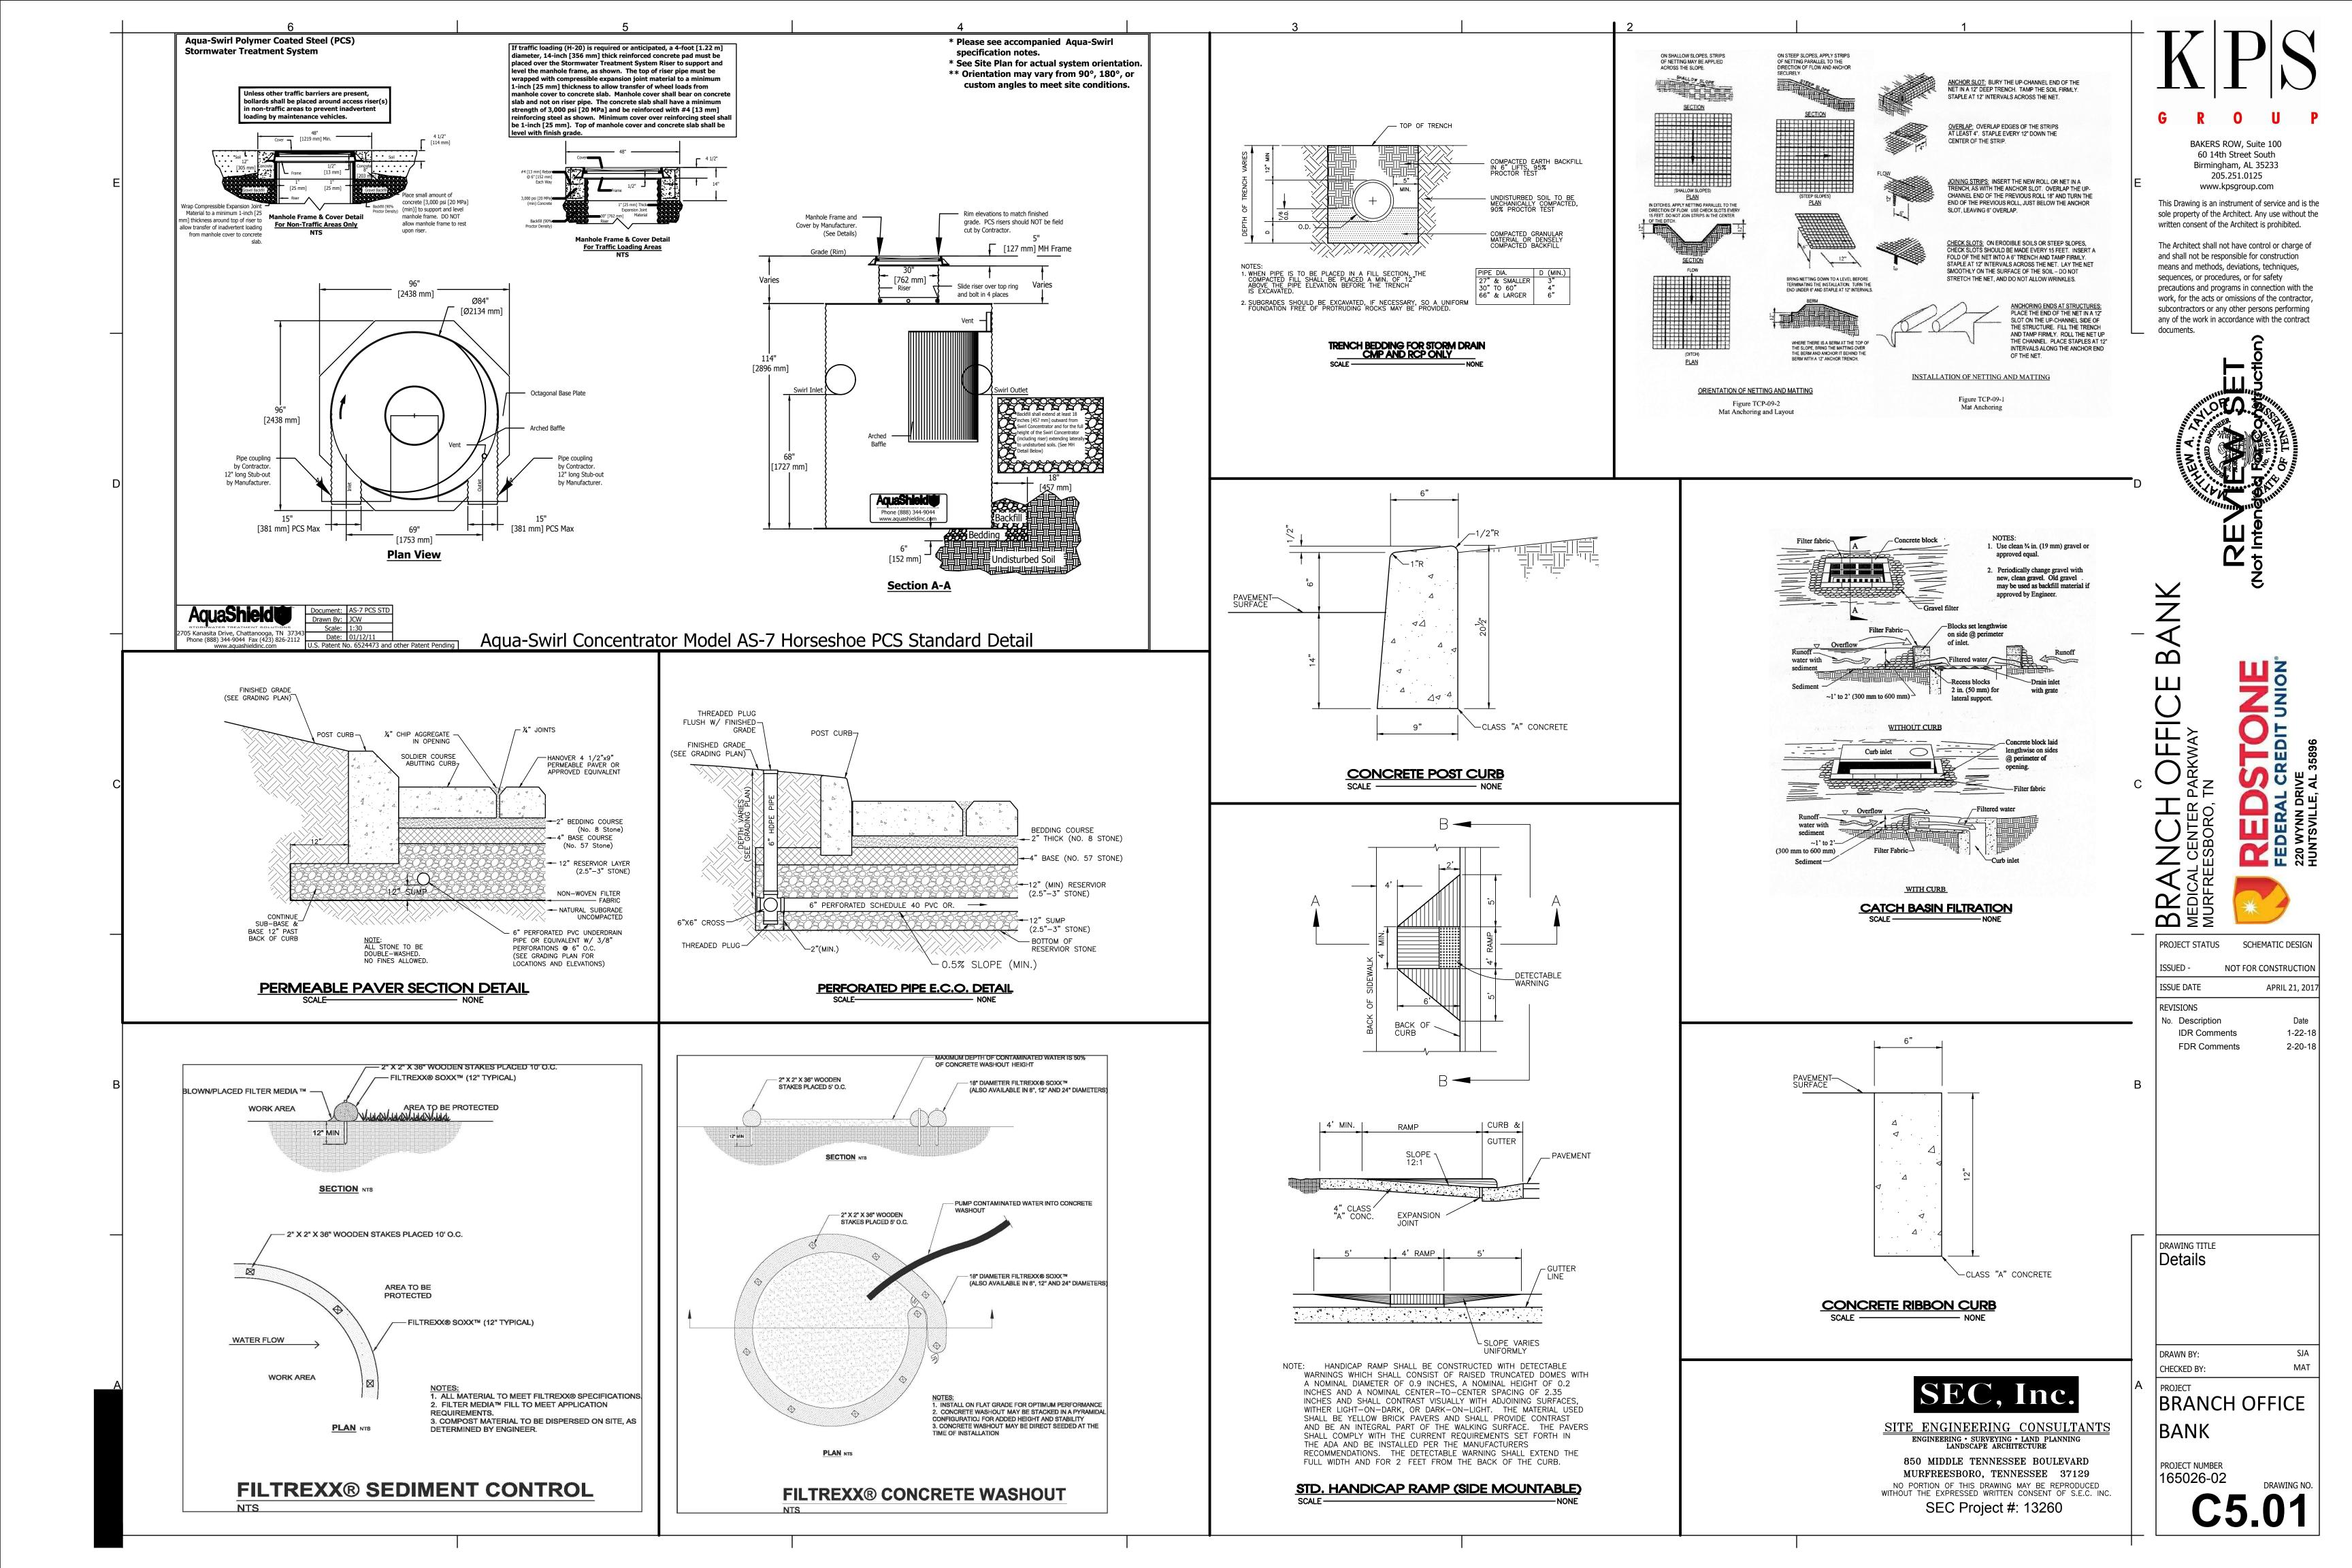

FEDERAL SECURITY AGENCY SOCIAL SECURITY ADMINISTRATION BUREAU OF FEDERAL CREDIT UNIONS

Redstone

FEDERAL CREDIT UNION

CHARTER NO. $\frac{754}{4}$

ORGANIZATION CERTIFICATE

FEDERAL CREDIT UNION

Redstone

	Charter No	544		
To Bureau of Federal (CREDIT UNIONS:			the state of the s
We, the undersigned	, do hereby associate our	selves as a Fe	deral credit	union for the
ourposes indicated in and	in accordance with the pr	ovisions of the	Federal Cred	lit Union Act,
•	ngress, 1st Session, entitl			
· · · · · · · · · · · · · · · · · · ·	a further market for seco	*		
· · · · · · · · · · · · · · · · · · ·	of small means credit for			
system of cooperative cred	lit, thereby helping to stal	bilize the cred	it structure	of the United
States"; we hereby reques	t approval of this organiz	ation certificat	e; we agree to	o comply with
he requirements of said	Act, with the terms of this	organization c	ertificate and	with all laws,
rules, and regulations nov	v or hereafter applicable	to Federal cre	dit unions; a	nd we hereby
certify that:		•	•	
			•	
(1) The name of the	is credit union shall be		*****************	
	Redstone		``````````````````````````````````````	C Jir IIi
B+		,	r ederai	Credit Union.
(a) III	·11	-4		
(2) This credit unio	on will maintain its office a	ät		,
	Huntsville,	Alabama		
		***************************************		,
and will anarote in the f	ollowing territory	,		
and will operate in the r	onowing torritory		· · · · · · · · · · · · · · · · · · ·	
	Madison Coun	ty, Alabama		
		,,,,,,,,,,,,,,,,,,,,,,,,,,,,,,,,,,,,,,,		
		•		

(3) The names and addresses of the subscribers to this certificate and the number of shares subscribed by each are as follows:

NAME	ADDRESS	SHARE	is
	423 Eustis Street,	•	
ames P. Lutz	Huntsville, Alabama	T	
	400-7th Ave. W.,		
ollier Lewter	Huntsville, Alabama	1	
	704 School Street,	_	
erald L. Davis	Huntsville, Alabama	1	,-
	208 N. Plymouth Road,		
tanley B. Stephens	Huntsville, Alabama	1	
illiam H. Key	New Hope, Alabama	1	
part .	522 Bonita Circle,		
tuart H. Jones	Huntsville, Alabama	1	
	701 College Hill Apts.,	_	
. W. Penick	Huntsville, Alabema	1	
	520 Hermitage Street,		
. W. Stutts, Jr.	Huntsville, Alabama	1	
	440 Eustis Street,	,	
esse C. Anderson	Huntsville, Alabama	1	
	Longwood Court,		
ulia Z. Harris	Huntsville, Alabama	1	
shford Todd	201 Sunset Drive, Huntsville, A of this credit union shall be \$5.00.	la. l	

(5) The field of membership shall be limited to those having the following common bond of association, occupation, or residence: Military personnel and civilian employees of the Ordnance Corps, employees of Thiokol Corporation, and Rohm and Haas Company stationed at Redstone Arsenal in Madison County, Alabama; employees of this credit union; members of their immediate families; and organizations of such persons.

amended

8-25-52 12-17-56 1-27-67 1-9-58 1-13-68 1-3-58 1-3-58 1-36-69 1-7-63 1-7-63 1-7-63 1-7-65 1-15-65 1-25-65 1-25-65 1-17-65

12-8-66

16-58350-2 U. S. GOVERNMENT PRINTING OFFICE

- (6) The term of this credit union's existence shall be perpetual; Provided, however, That upon the finding that this credit union is bankrupt or insolvent or has violated any provision of this organization certificate, of the bylaws, of the Federal Credit Union Act including any amendments thereto or thereof, or of any regulations issued thereunder, this organization certificate may be suspended or revoked under the provisions of Section 16(b) of the Federal Credit Union Act.
- (7) This certificate is made to enable the undersigned to avail themselves of the advantages of said Act.
- (8) The management of this credit union, the conduct of its affairs, and the powers, duties, and privileges of its directors, officers, committees and membership shall be set forth in the approved bylaws and any approved amendments thereto or thereof.

IN WITNESS WHEREOF we' have hereunto subscribed our names this I day of October 1951

Sunda L. Davis Jesse Judenson

Stonly & Stephens July Ashford Bad

Subscribed before me, on officer competent to administer gaths, at the ntaville ala this I day of October

Signed Allanda Judenson

Title Notales Rubbies

Title Notales Rubbies

APPROVAL OF ORGANIZATION CERTIFICATE

Pursuant to the p	rovisions of Section 4 a	nd/or Section 16(c) of the
Federal Credit Union Ac	ct, as amended, and Section	n 2 of Public Law 813, 80th
Congress, 2d Session, the	e foregoing organization co	ertificate of
	Redstone	TO 1 of Confidential
	Treat Anto	Federal Credit Union

Bureau of Federal Credit Unions Social Security Administration Federal Security Agency

IN WITNESS WHEREOF, the Social Security Administration has hereunto affixed its seal.